

# The Sizewell C Project

6.6 Volume 5 Two Village Bypass
Chapter 2 Description of Two Village Bypass
Appendix 2A Proposed Development Drawings

Revision: 1.0

Applicable Regulation: Regulation 5(2)(a)

PINS Reference Number: EN010012

May 2020

Planning Act 2008 Infrastructure Planning (Applications: Prescribed Forms and Procedure) Regulations 2009





#### **NOT PROTECTIVELY MARKED**

# APPENDIX 2A – TWO VILLAGE BYPASS PROPOSED DEVELOPMENT DRAWINGS

#### LIST OF CONTENTS

#### Plans from the Book of Plans - Book 2

Drawing title	DCO Drawing number	Doc. Ref.
Works Plans		
Works Plan Key Plan	SZC-SZ0204-XX-000-DRW-100480	2.3
Two Village Bypass Works Plan Sheet 17 of 27	SZC-SZ0204-XX-000-DRW-100252	2.3
Two Village Bypass Works Plan Sheet 18 of 27	SZC-SZ0204-XX-000-DRW-100462	2.3
Highway layout plans, profiles and gene	eral arrangements	
Two Village Bypass Proposed General Arrangement and Profiles Sheet 1 of 2	SZC-SZ0204-XX-000-DRW-100038	2.8
Two Village Bypass Proposed General Arrangement and Profiles Sheet 2 of 2	SZC-SZ0204-XX-000-DRW-100522	2.8
Two Village Bypass A12/A1094 Eastern Roundabout Proposed General Arrangement	SZC-SZ0204-XX-000-DRW-100039	2.8
Two Village Bypass A12 Western Roundabout Proposed General Arrangement	SZC-SZ0204-XX-000-DRW-100040	2.8
Two Village Bypass A12/A1094 Eastern Roundabout Proposed Profiles	SZC-SZ0204-XX-000-DRW-100450	2.8
Two Village Bypass A12 Western Roundabout Proposed Profiles	SZC-SZ0204-XX-000-DRW-100451	2.8
Two Village Bypass Proposed Staggered Junction Plan and Profiles	SZC-SZ0204-XX-000-DRW-100452	2.8
River Alde Road Overbridge Proposed General Arrangement and Elevation	SZC-SZ0204-XX-000-DRW-100293	2.8
Foxburrow Wood Footbridge Proposed General Arrangement and Elevation	SZC-SZ0204-XX-000-DRW-100290	2.8
Cross-sections		
Two Village Bypass Cross Sections	SZC-SZ0204-XX-000-DRW-100443	2.8

edfenergy.com





#### SIZEWELL C PROJECT – ENVIRONMENTAL STATEMENT


#### **NOT PROTECTIVELY MARKED**


Drawing title	DCO Drawing number	Doc. Ref.
Foxburrow Wood Footbridge Key Plan for Sections	SZC-SZ0204-XX-000-DRW-100291	
Foxburrow Wood Footbridge Cross Sections	SZC-SZ0204-XX-000-DRW-100292	2.8
River Alde Overbridge Key Plan for Cross Sections	SZC-SZ0204-XX-000-DRW-100294	
River Alde Overbridge Proposed Cross Sections	SZC-SZ0204-XX-000-DRW-100295	2.8
Rights of way plans		
Two Village Bypass Rights of Way Plan Sheet 17 of 27	SZC-SZ0204-XX-000-DRW-100336	2.4
Two Village Bypass Rights of Way Plan Sheet 18 of 27	SZC-SZ0204-XX-000-DRW-100337	2.4


edfenergy.com

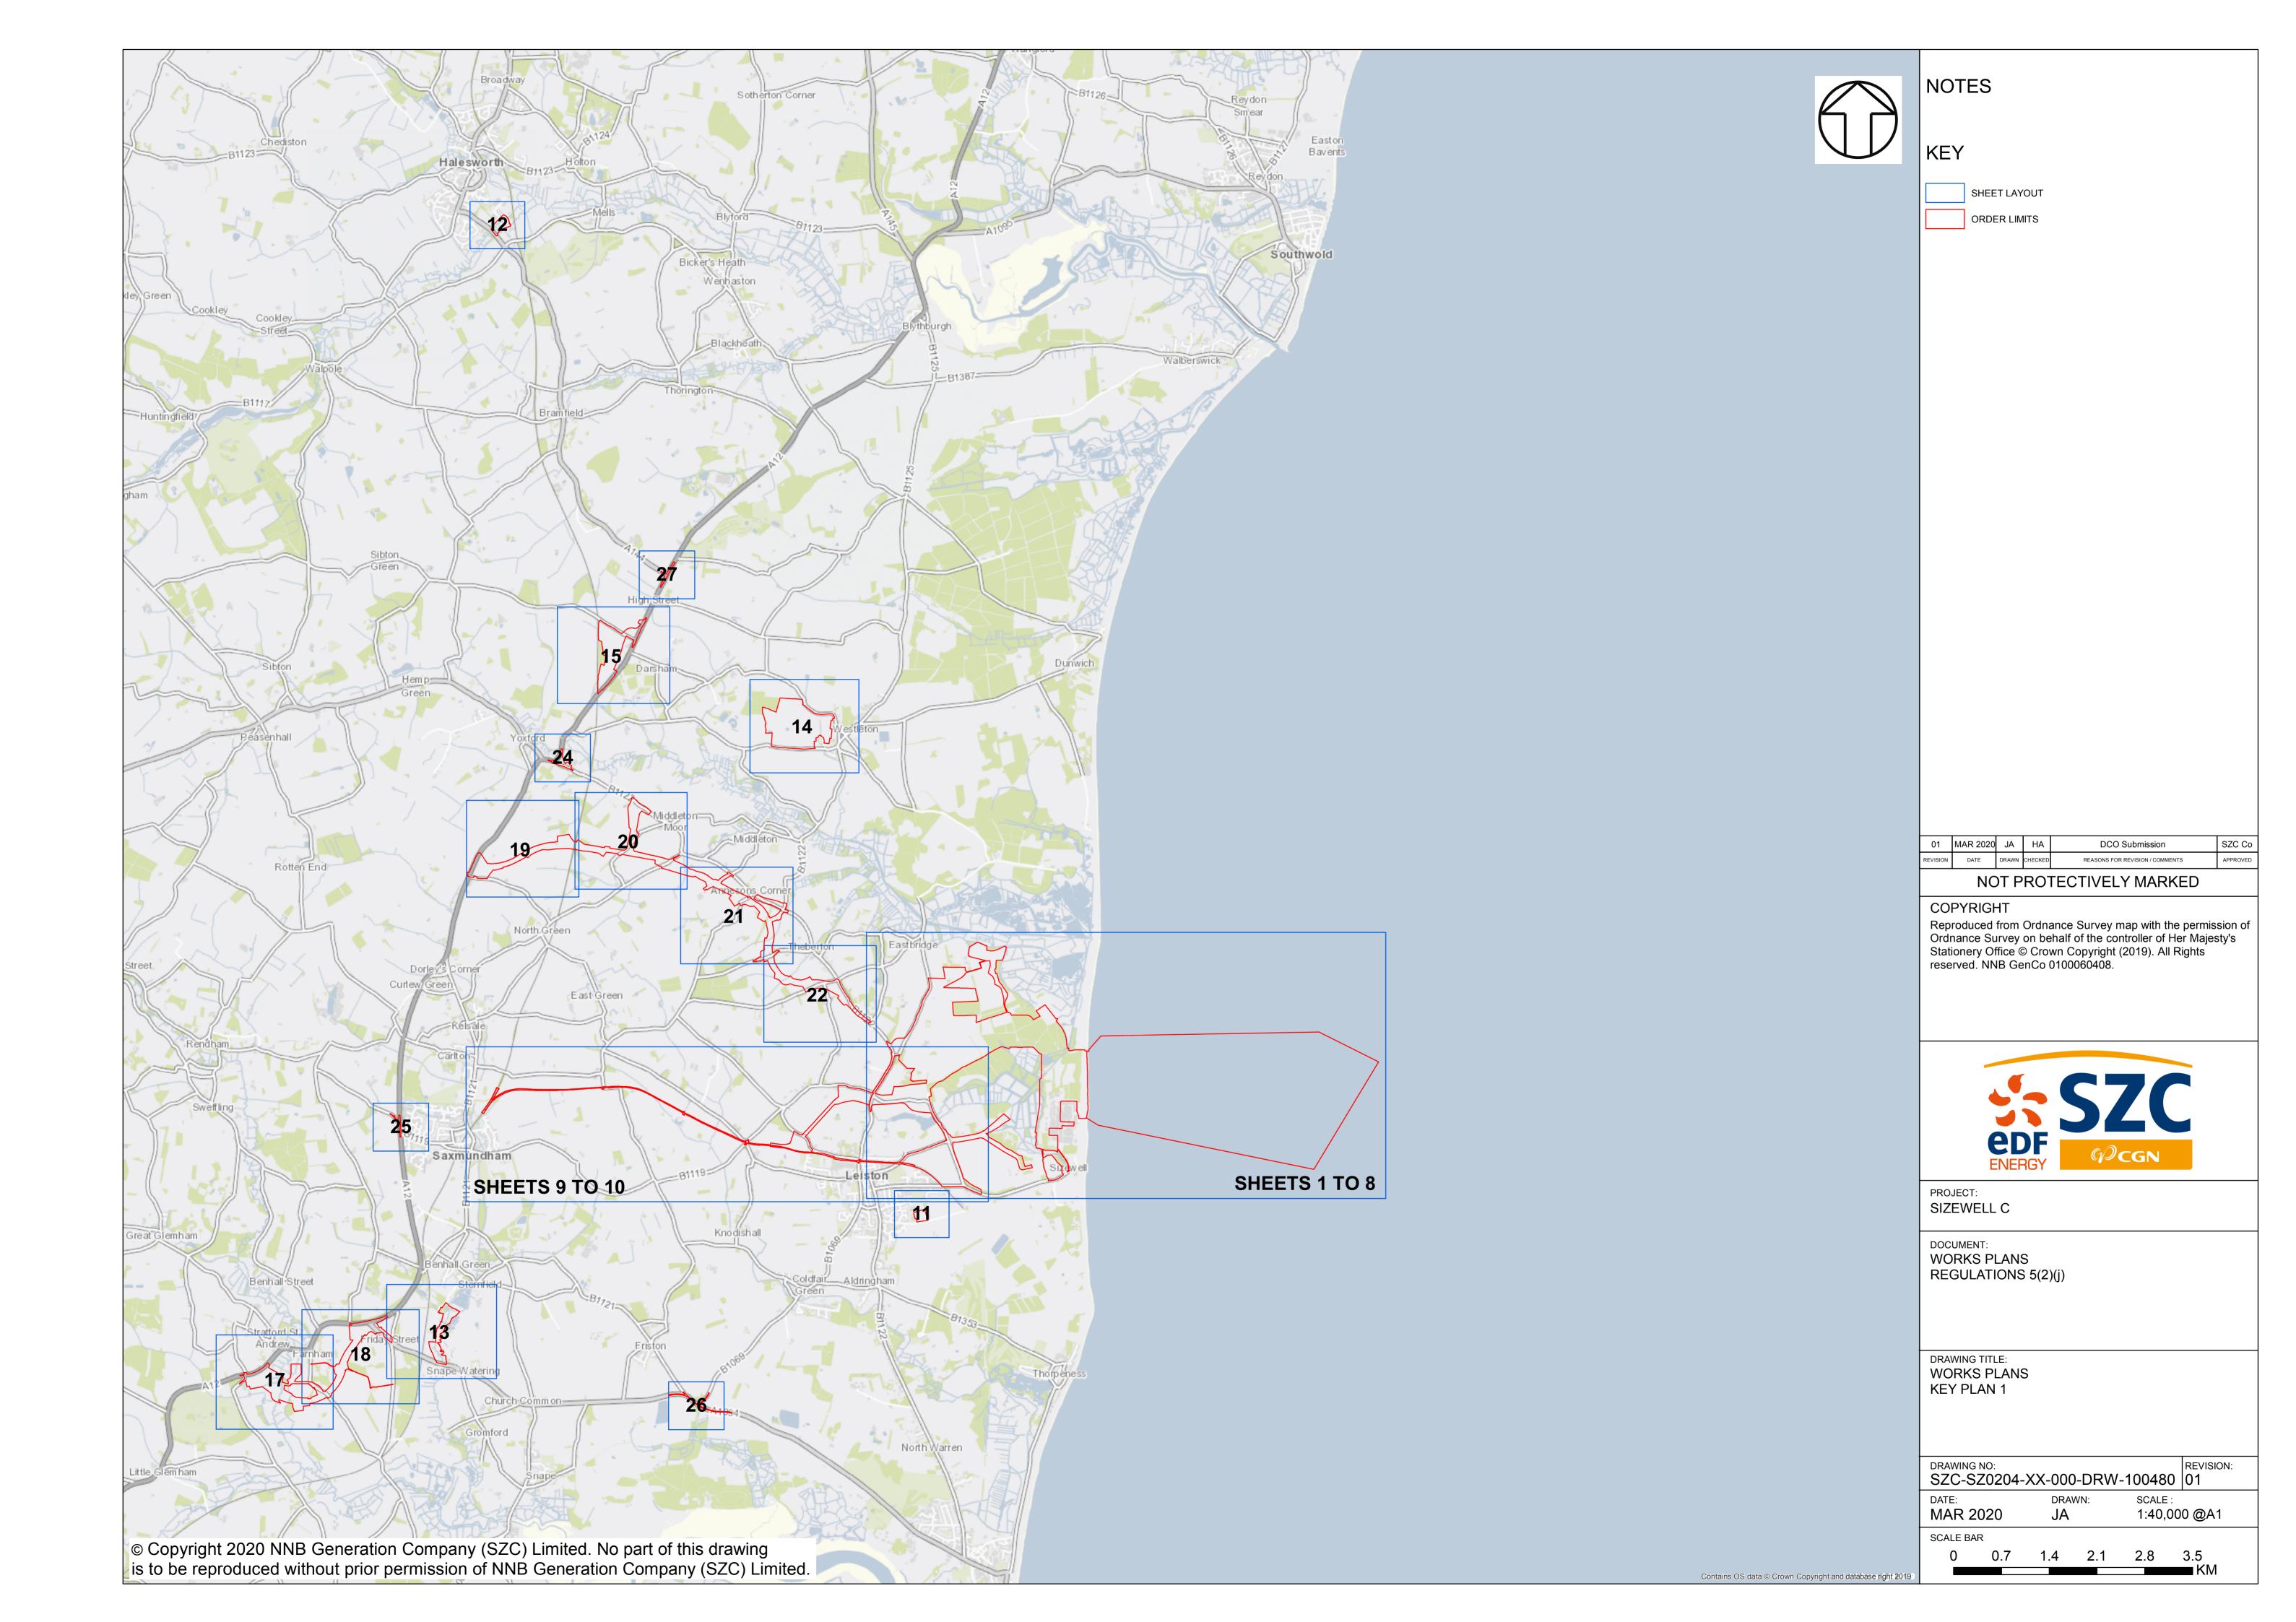


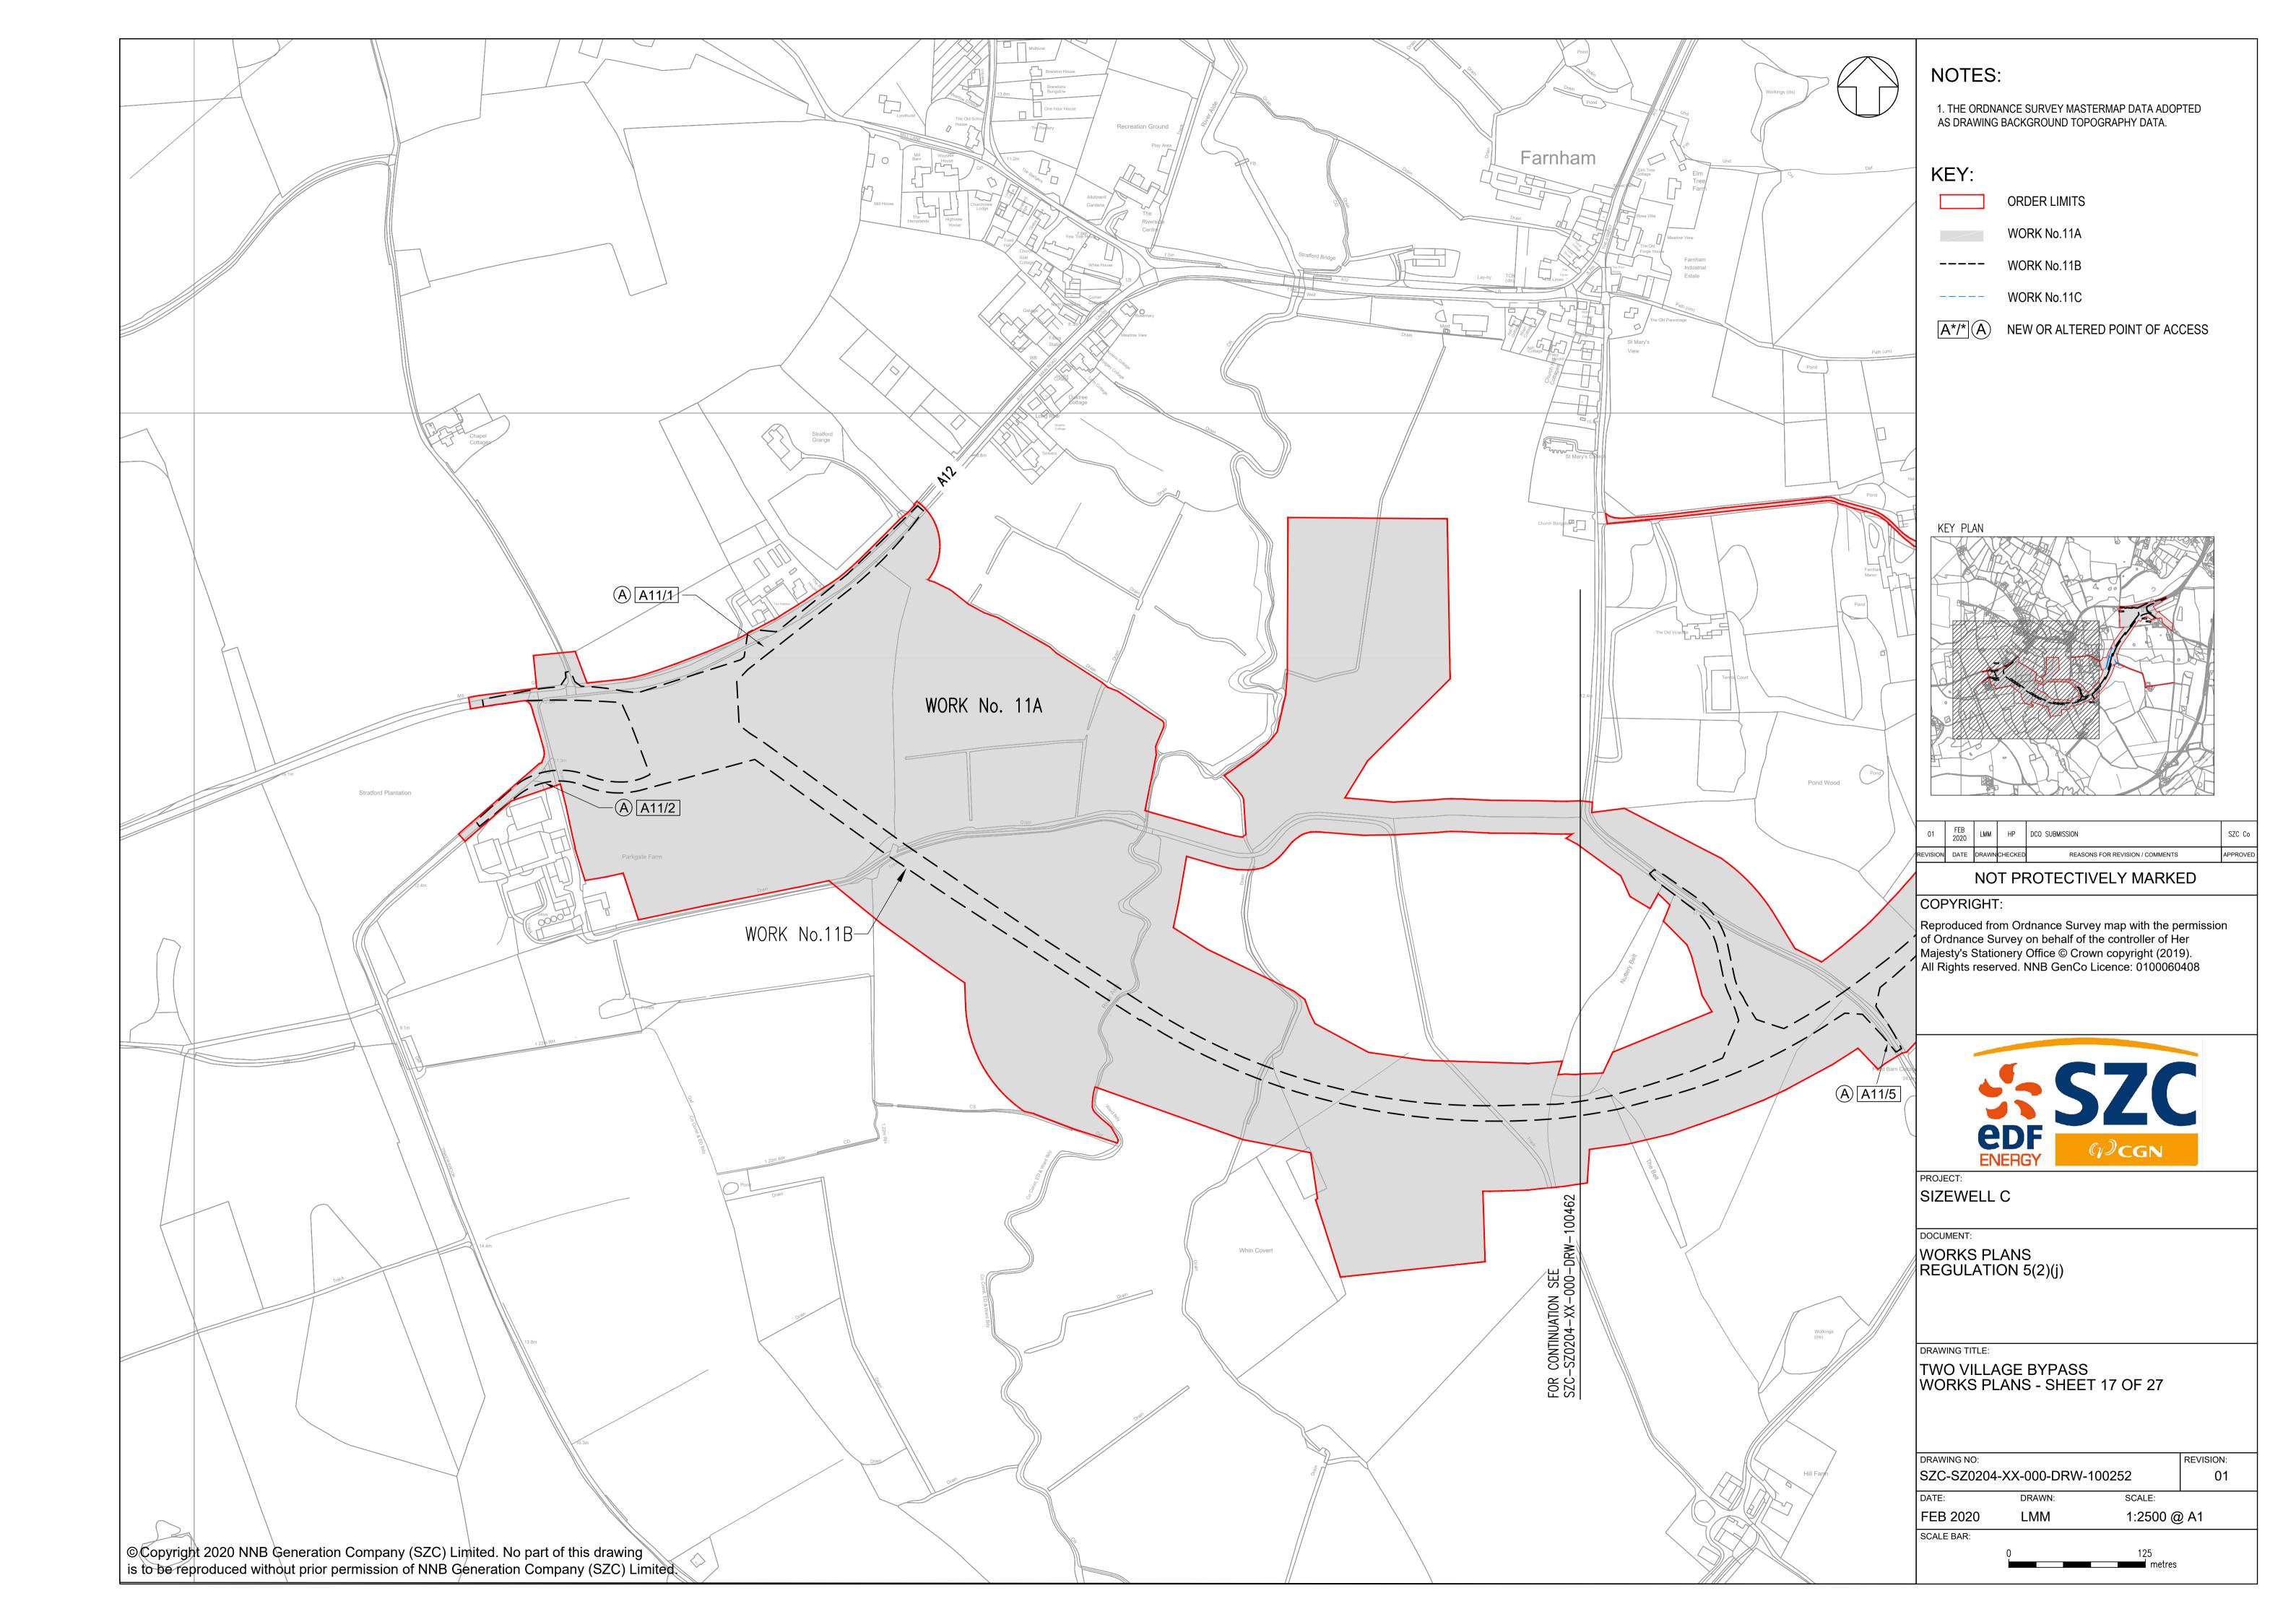


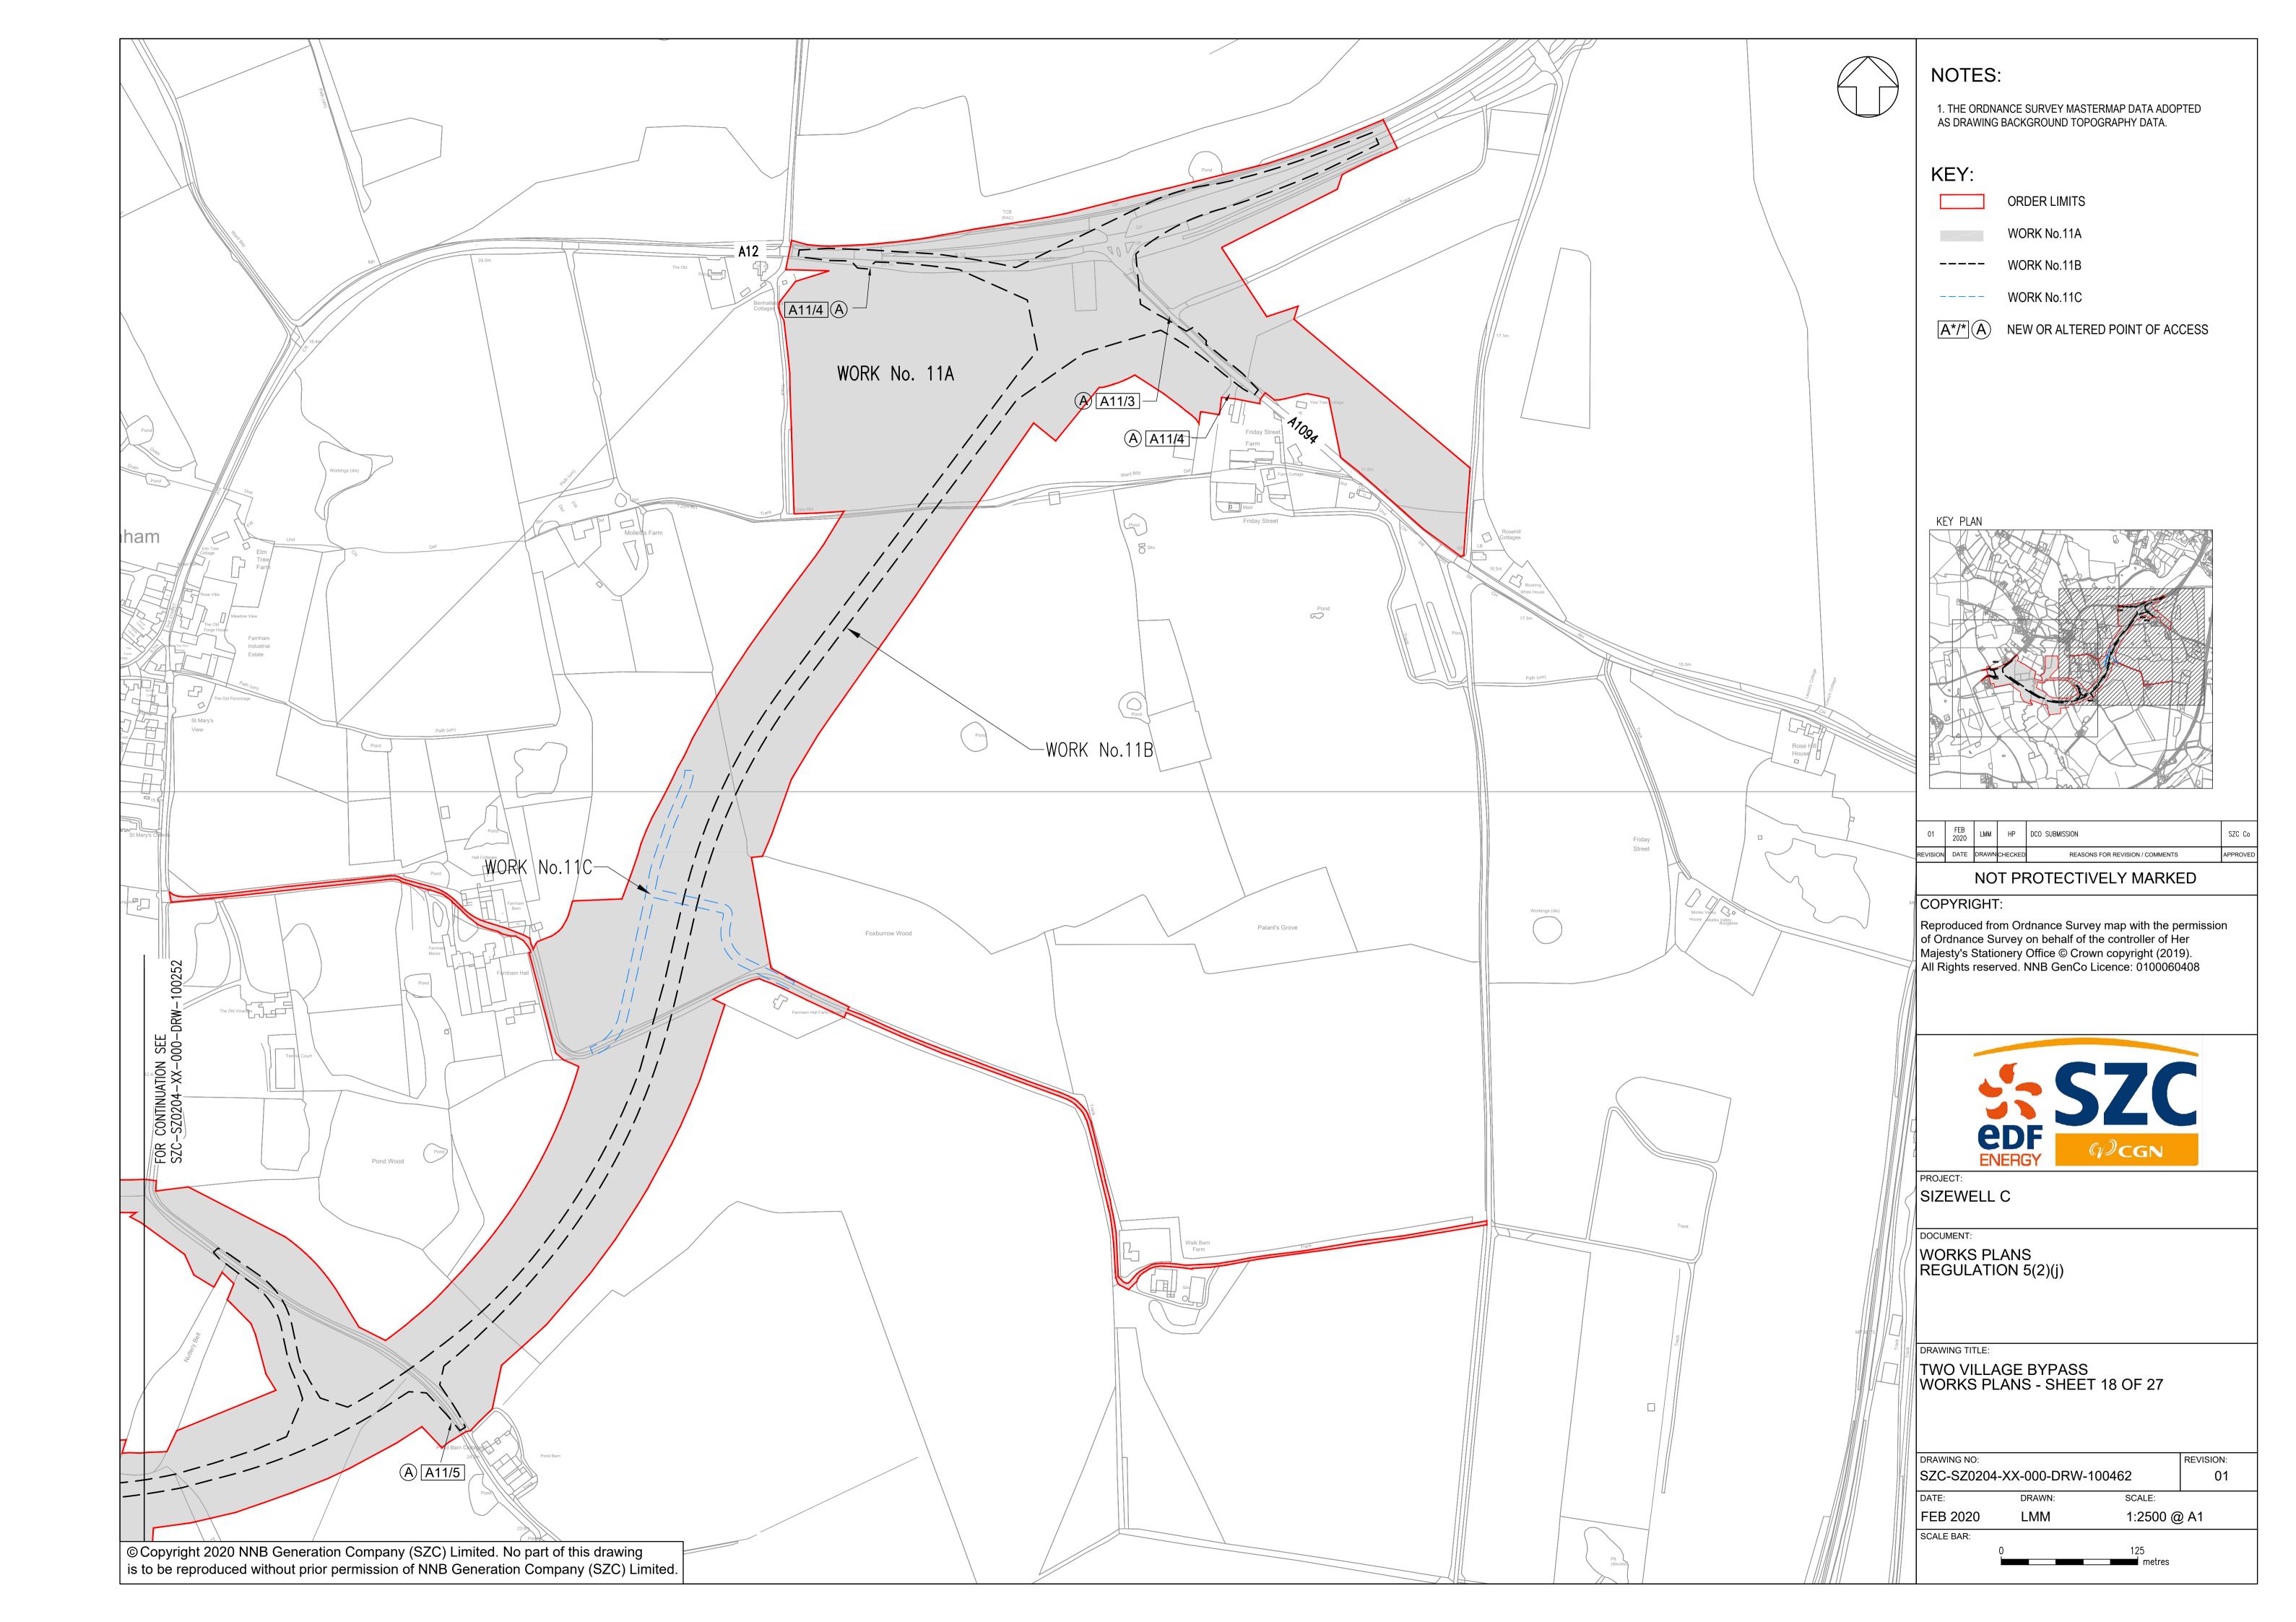


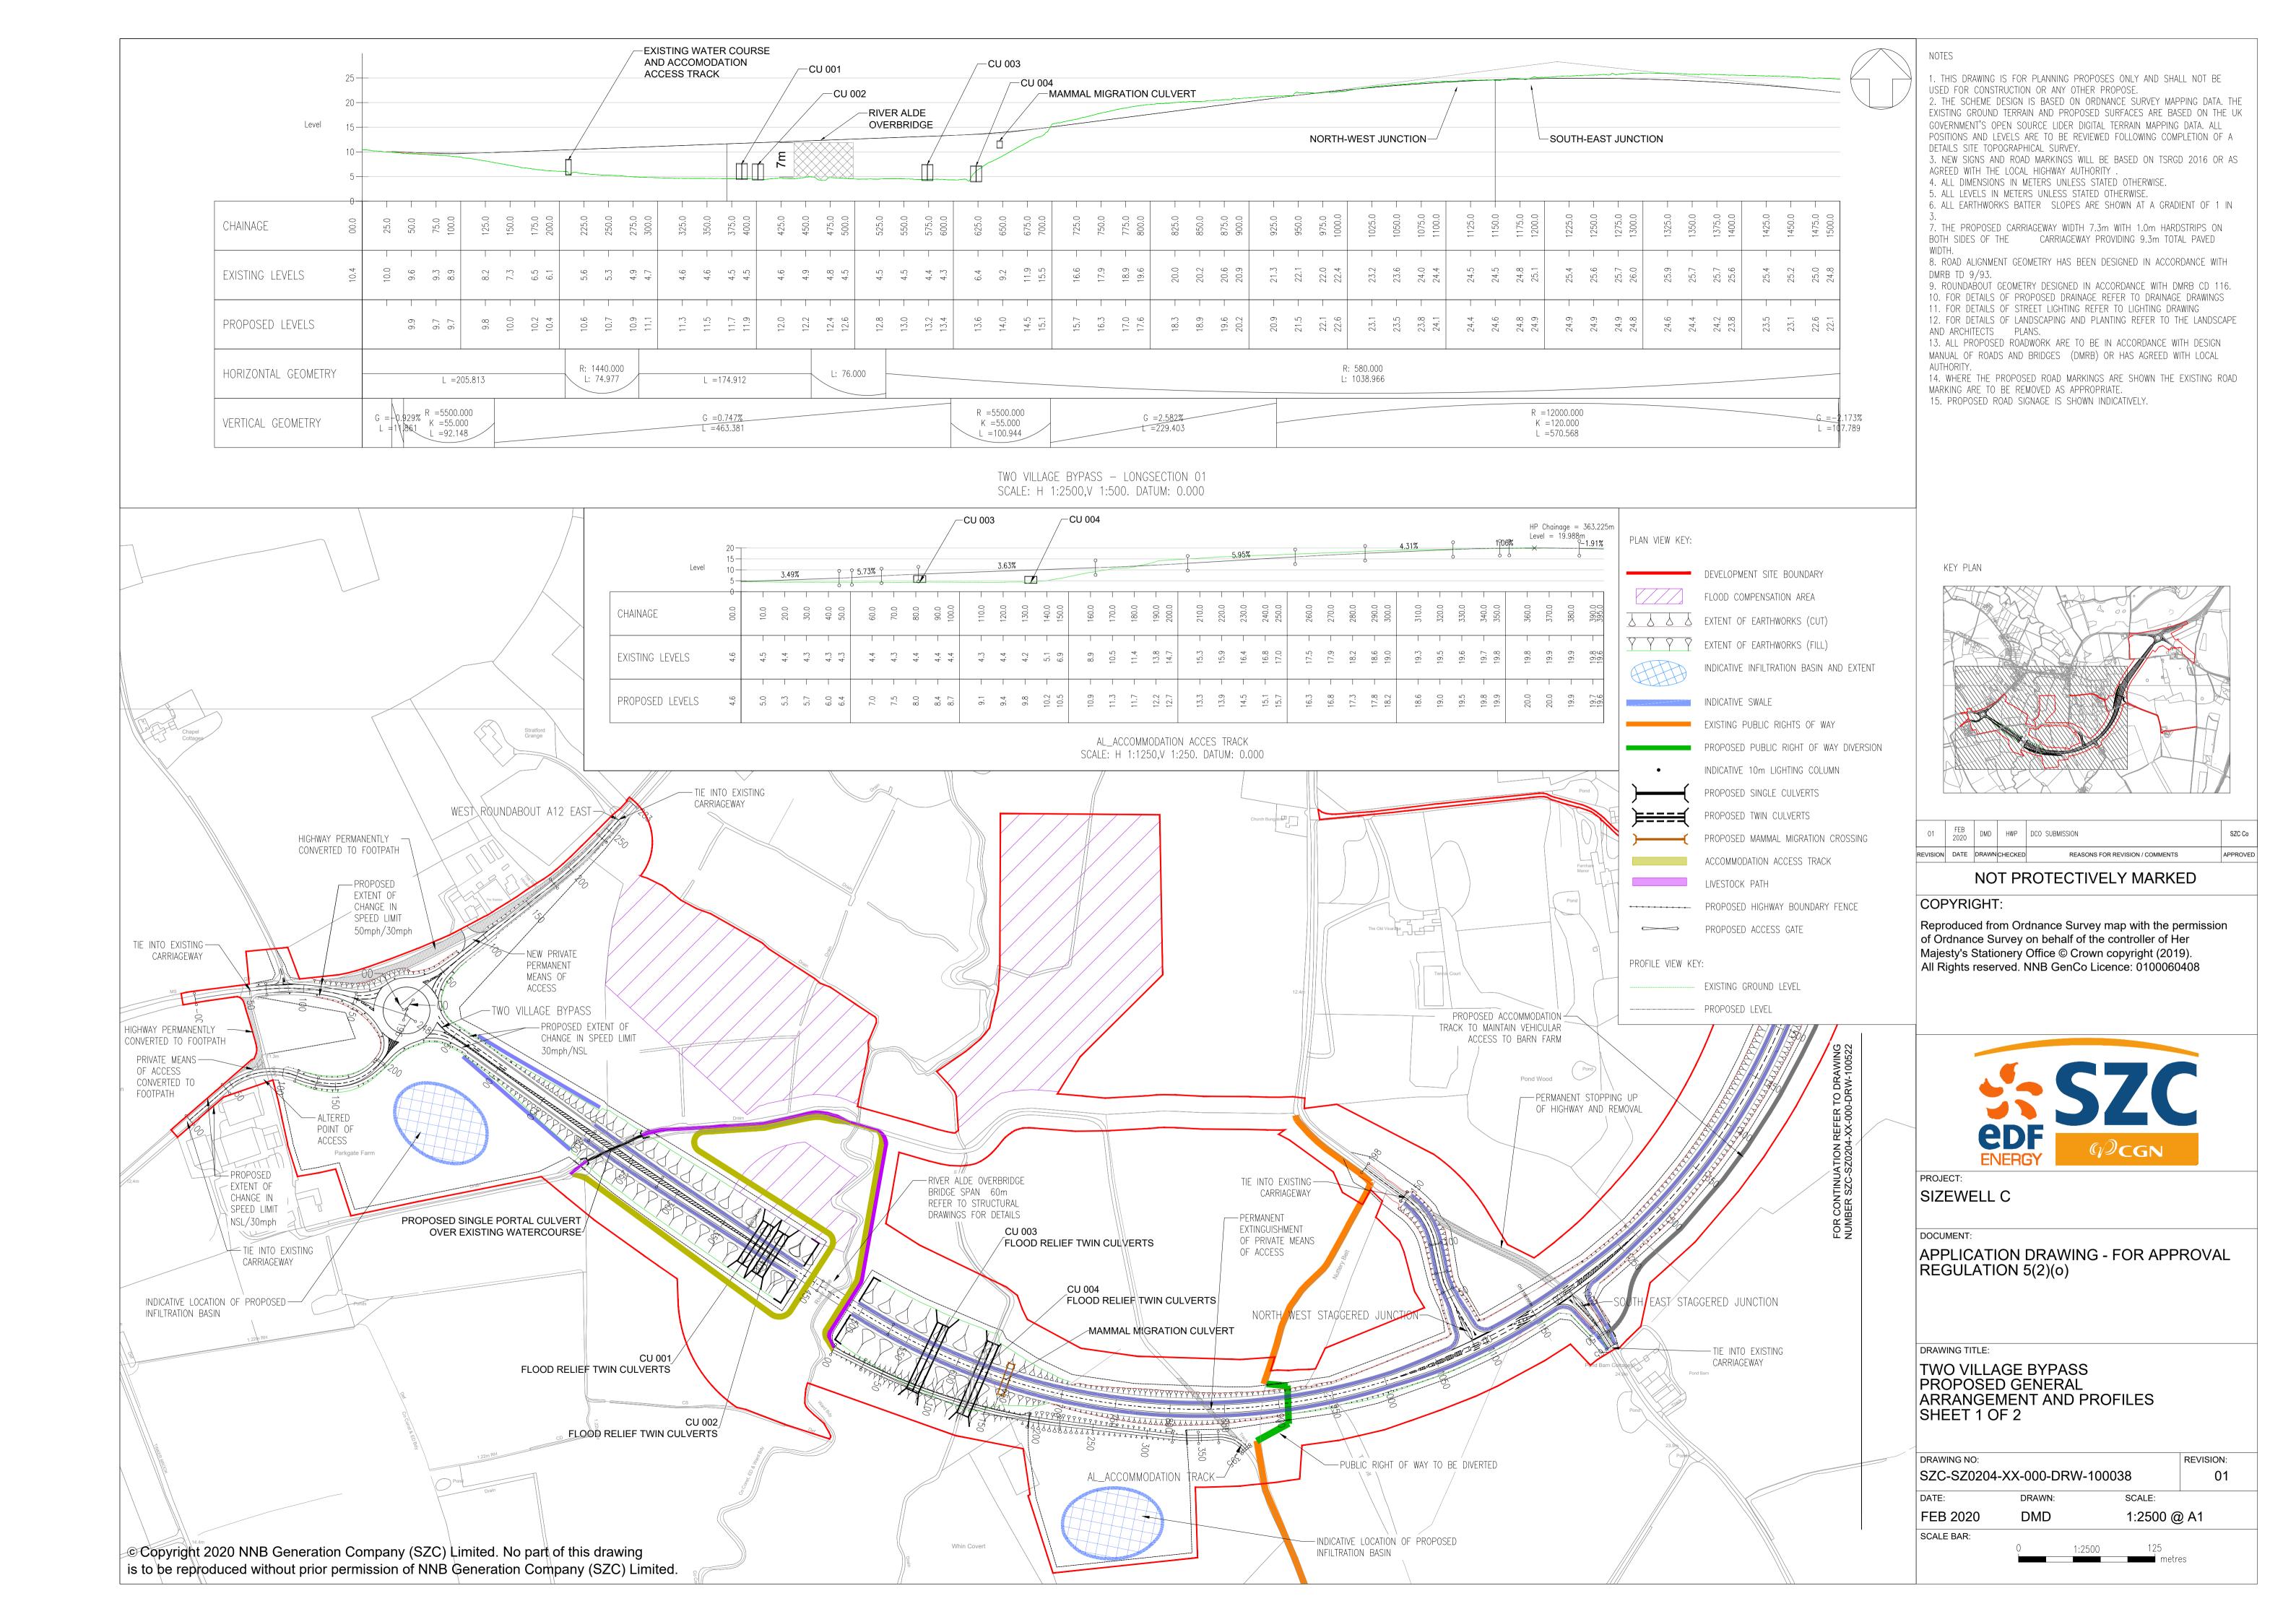

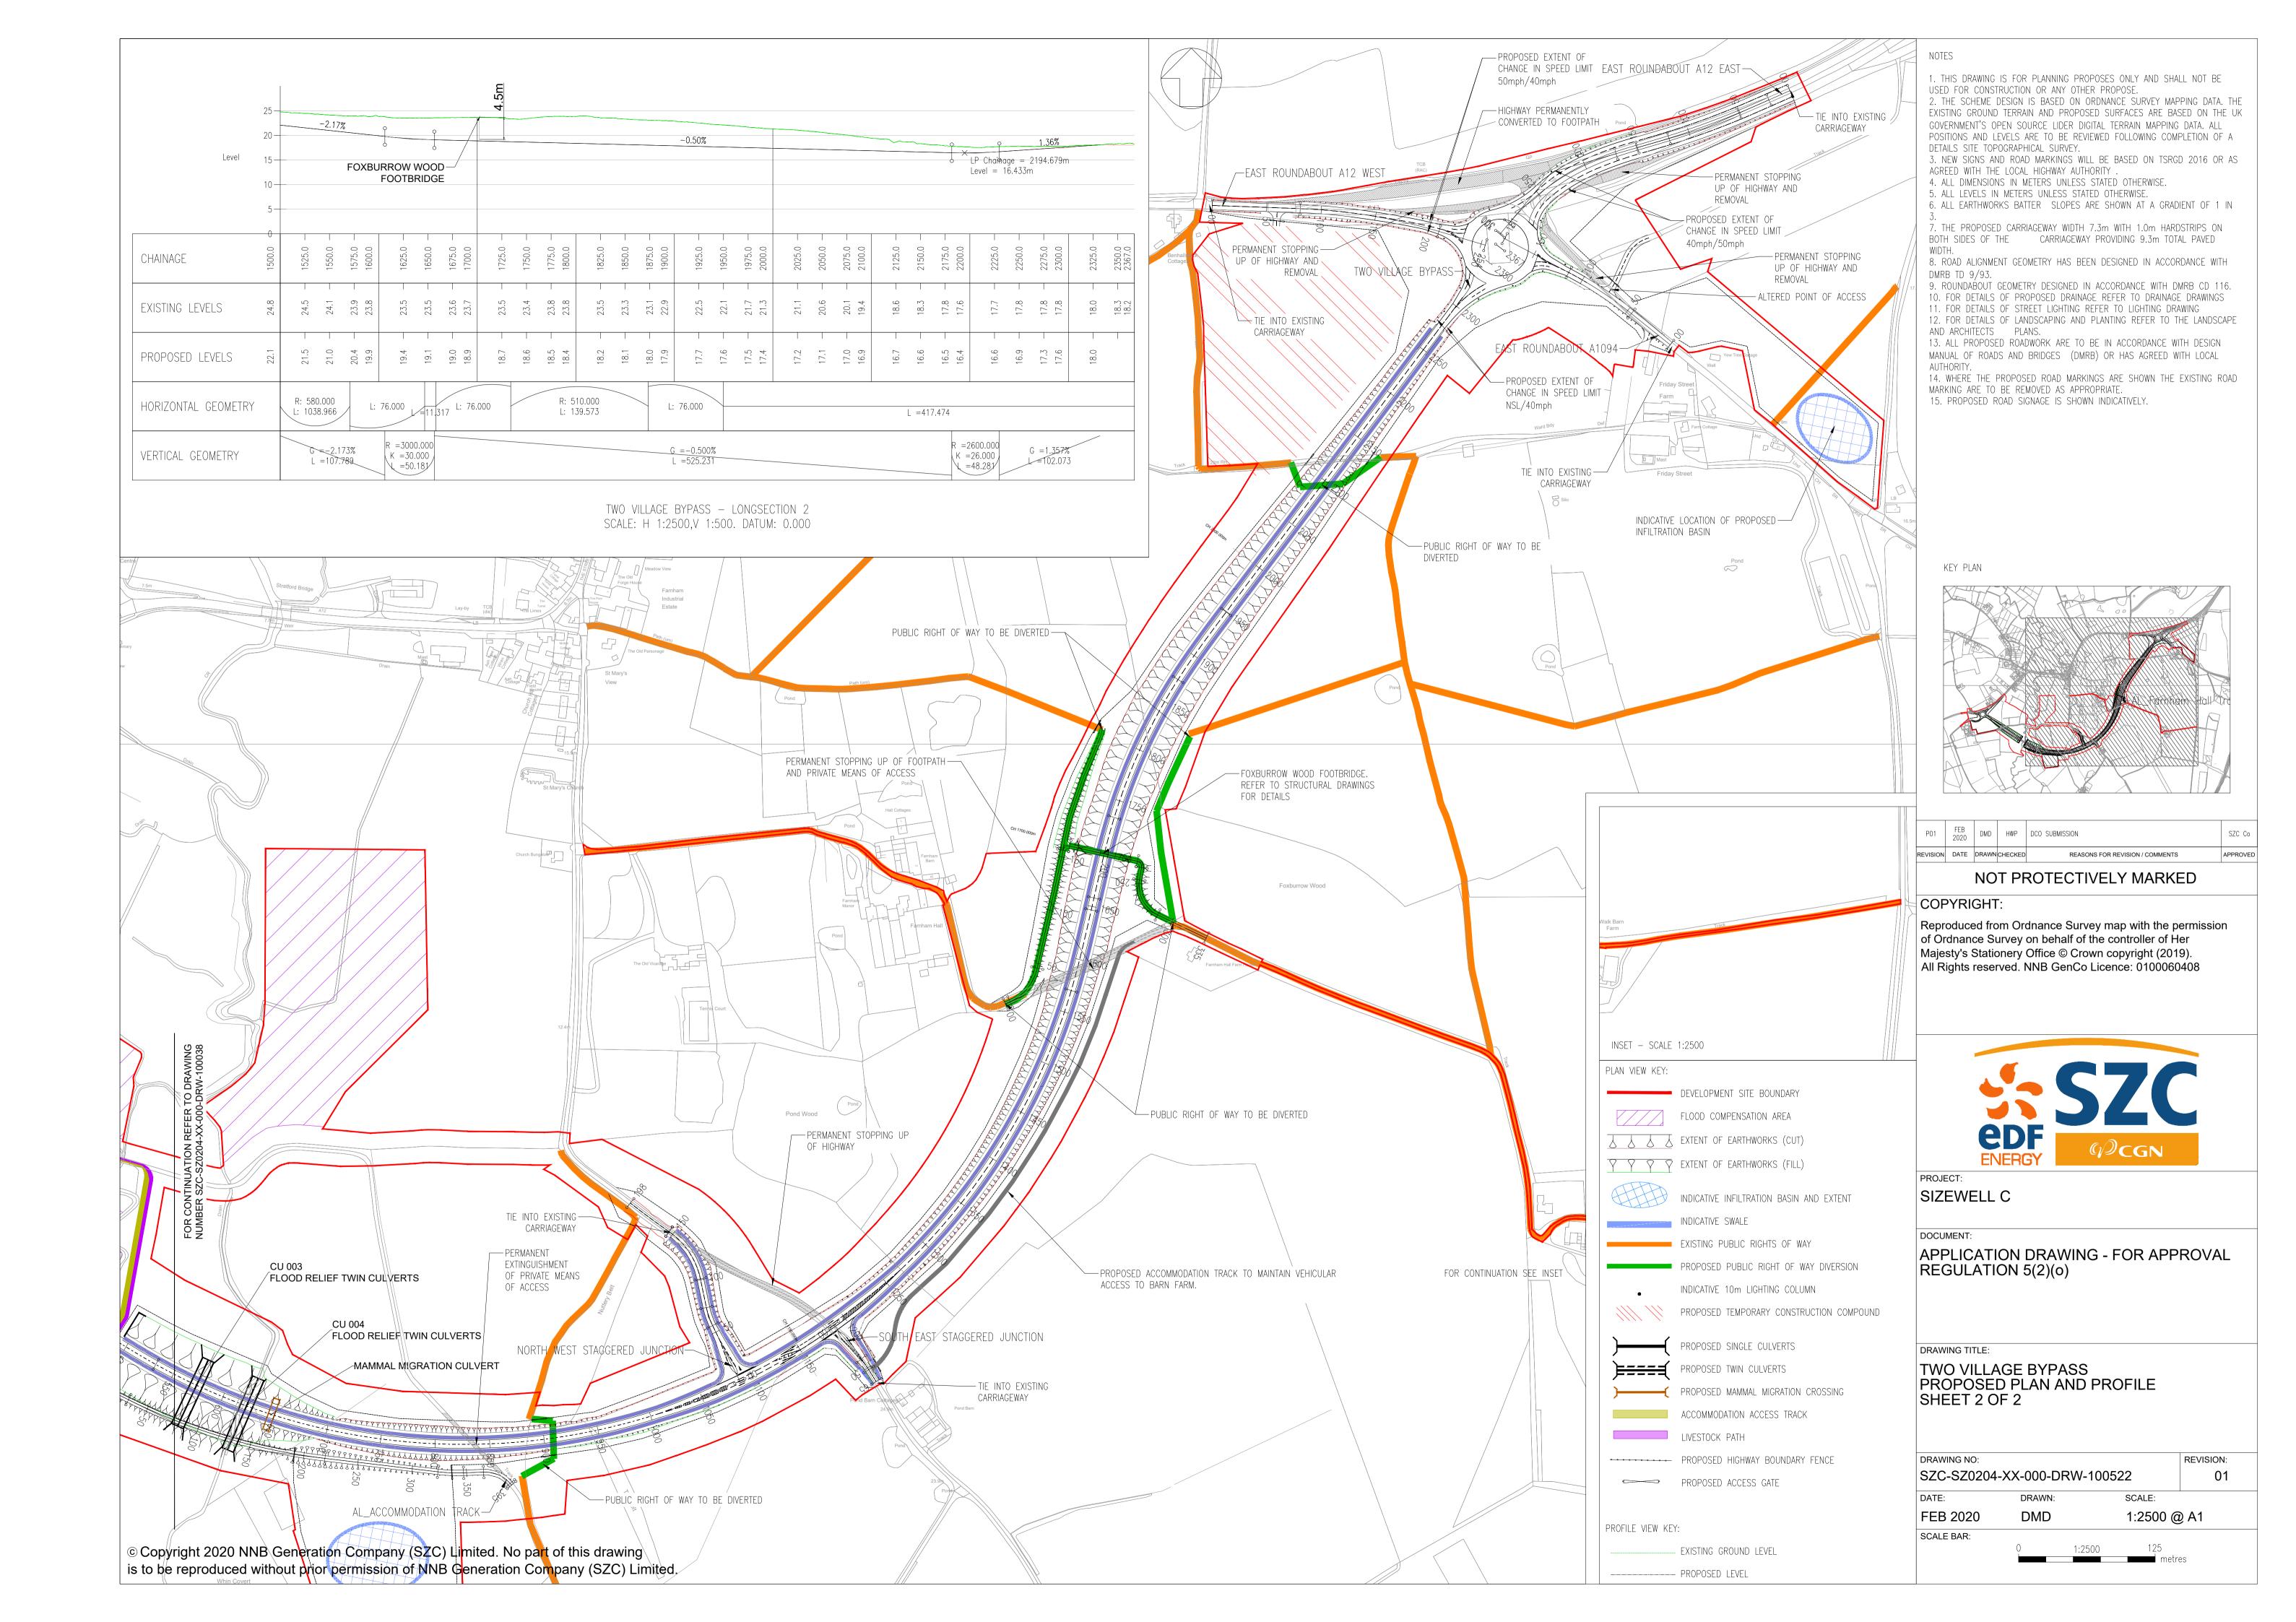


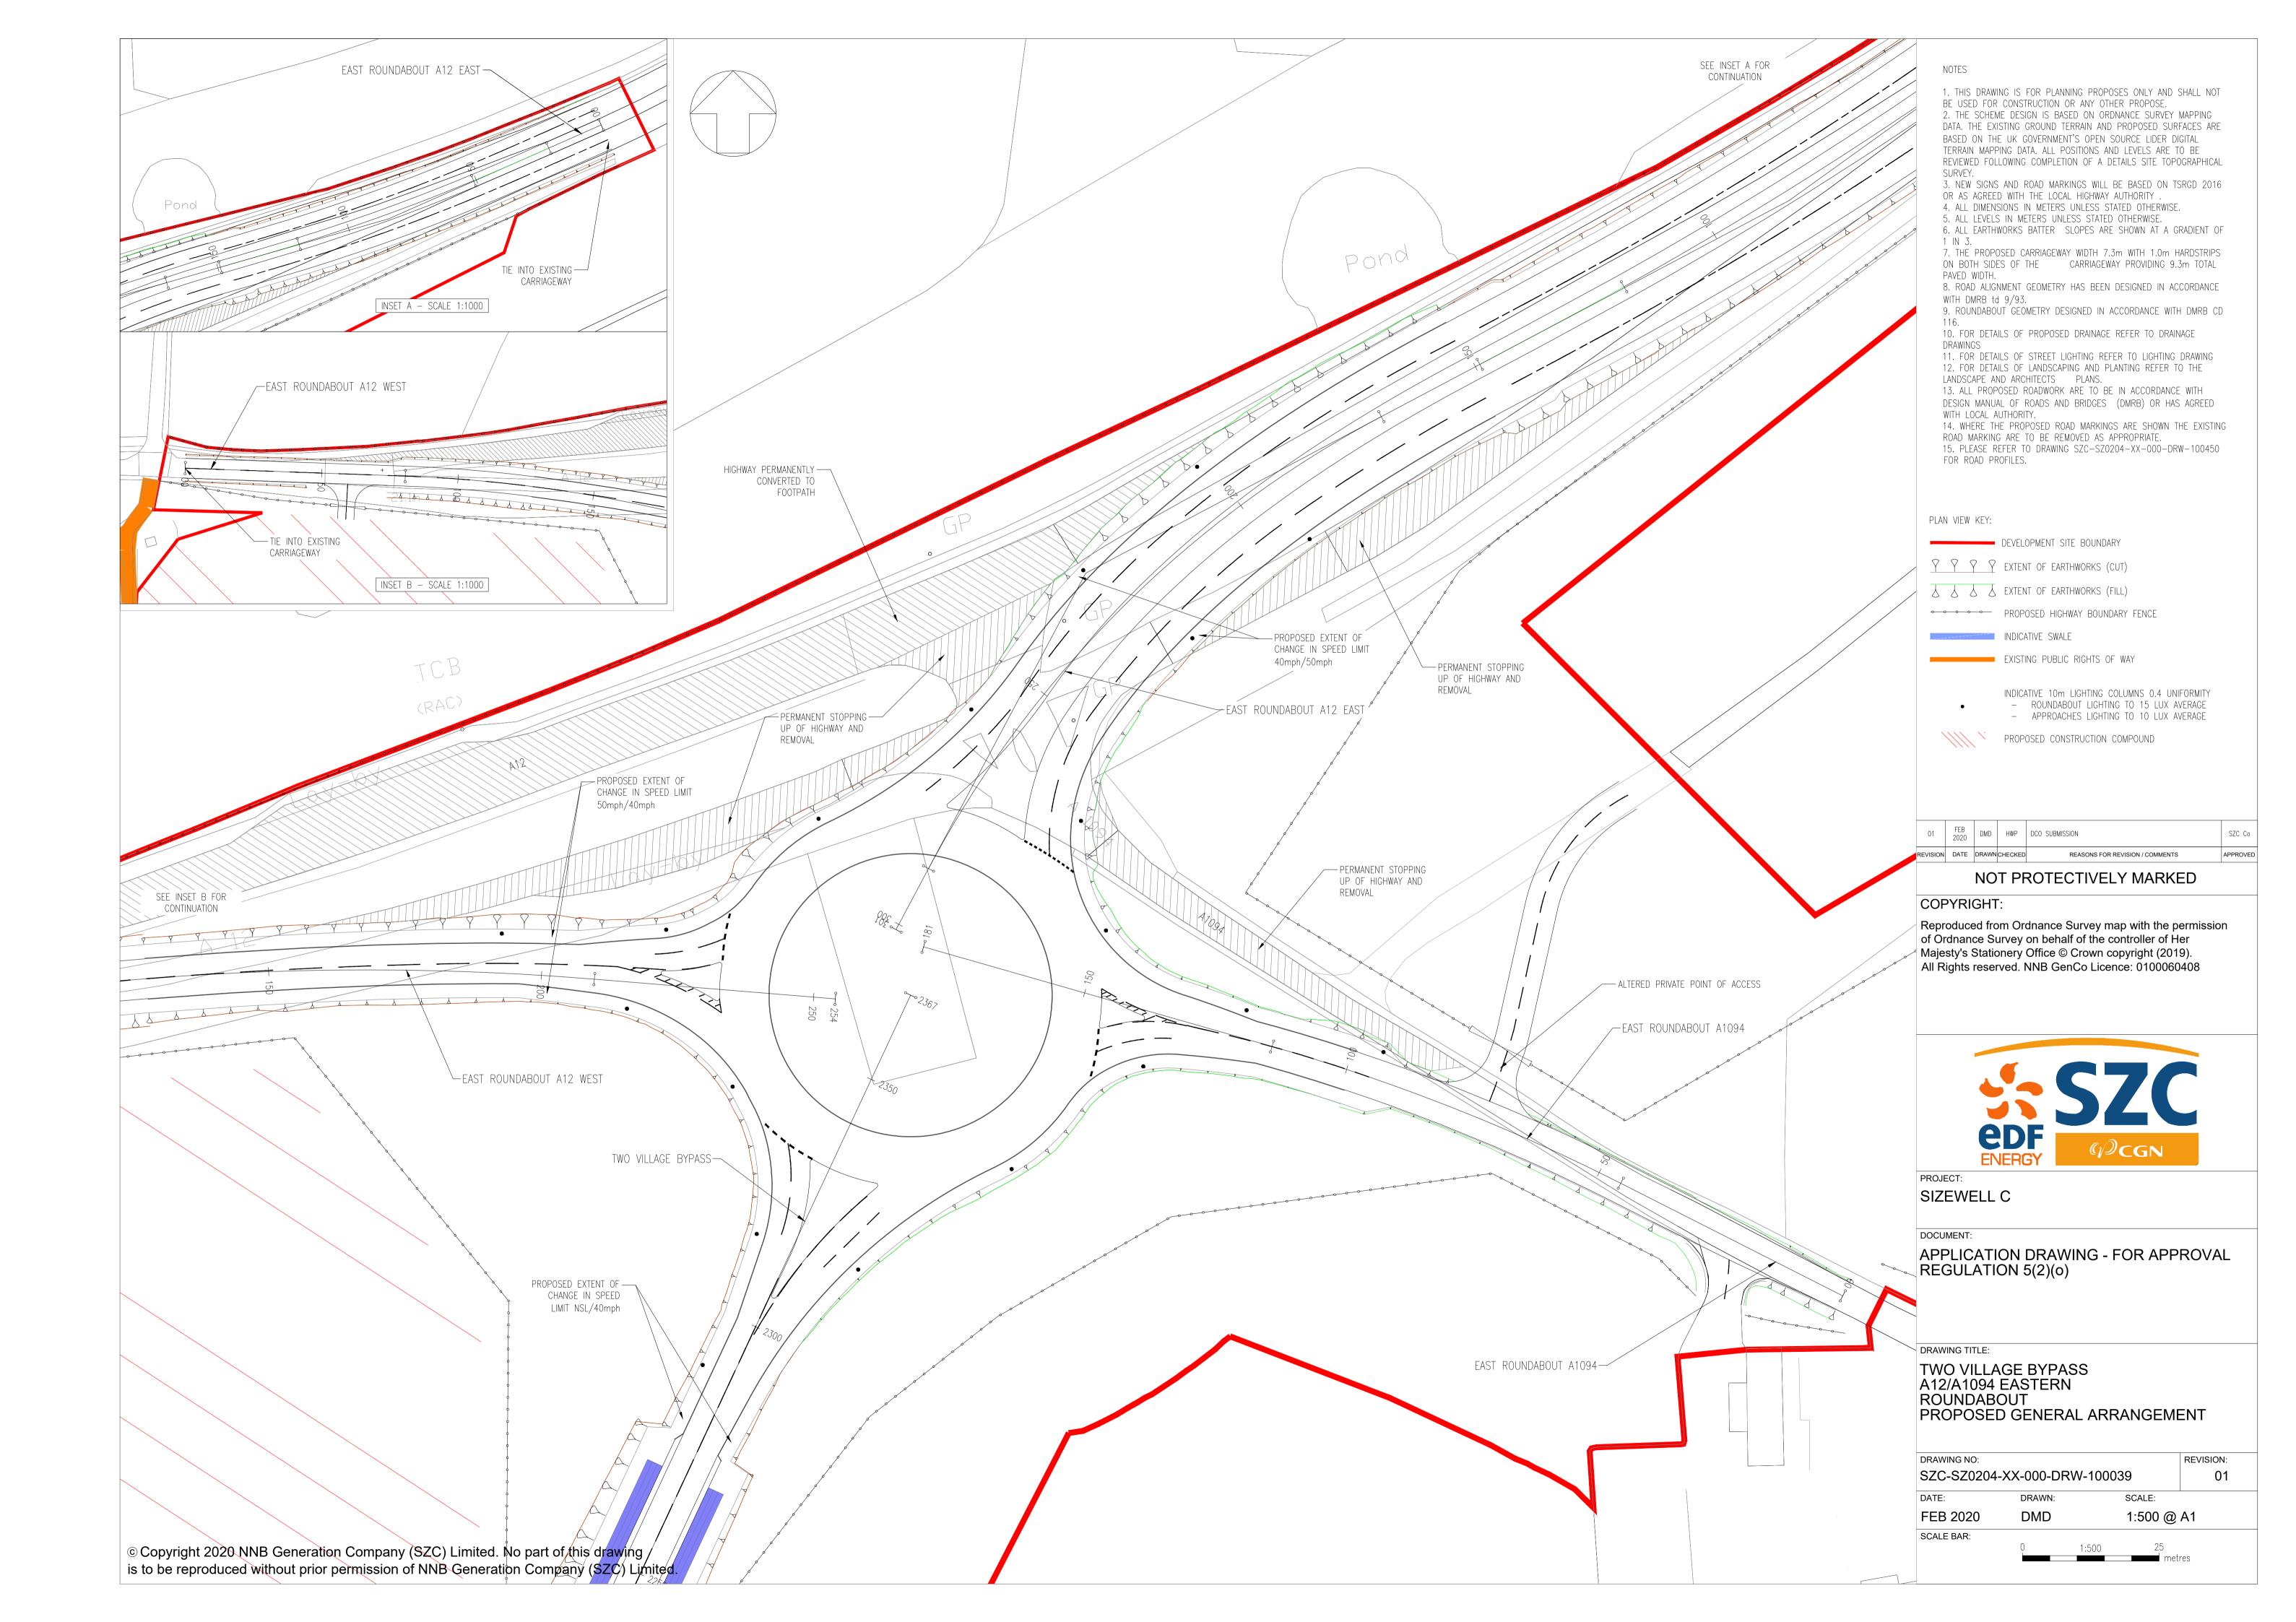

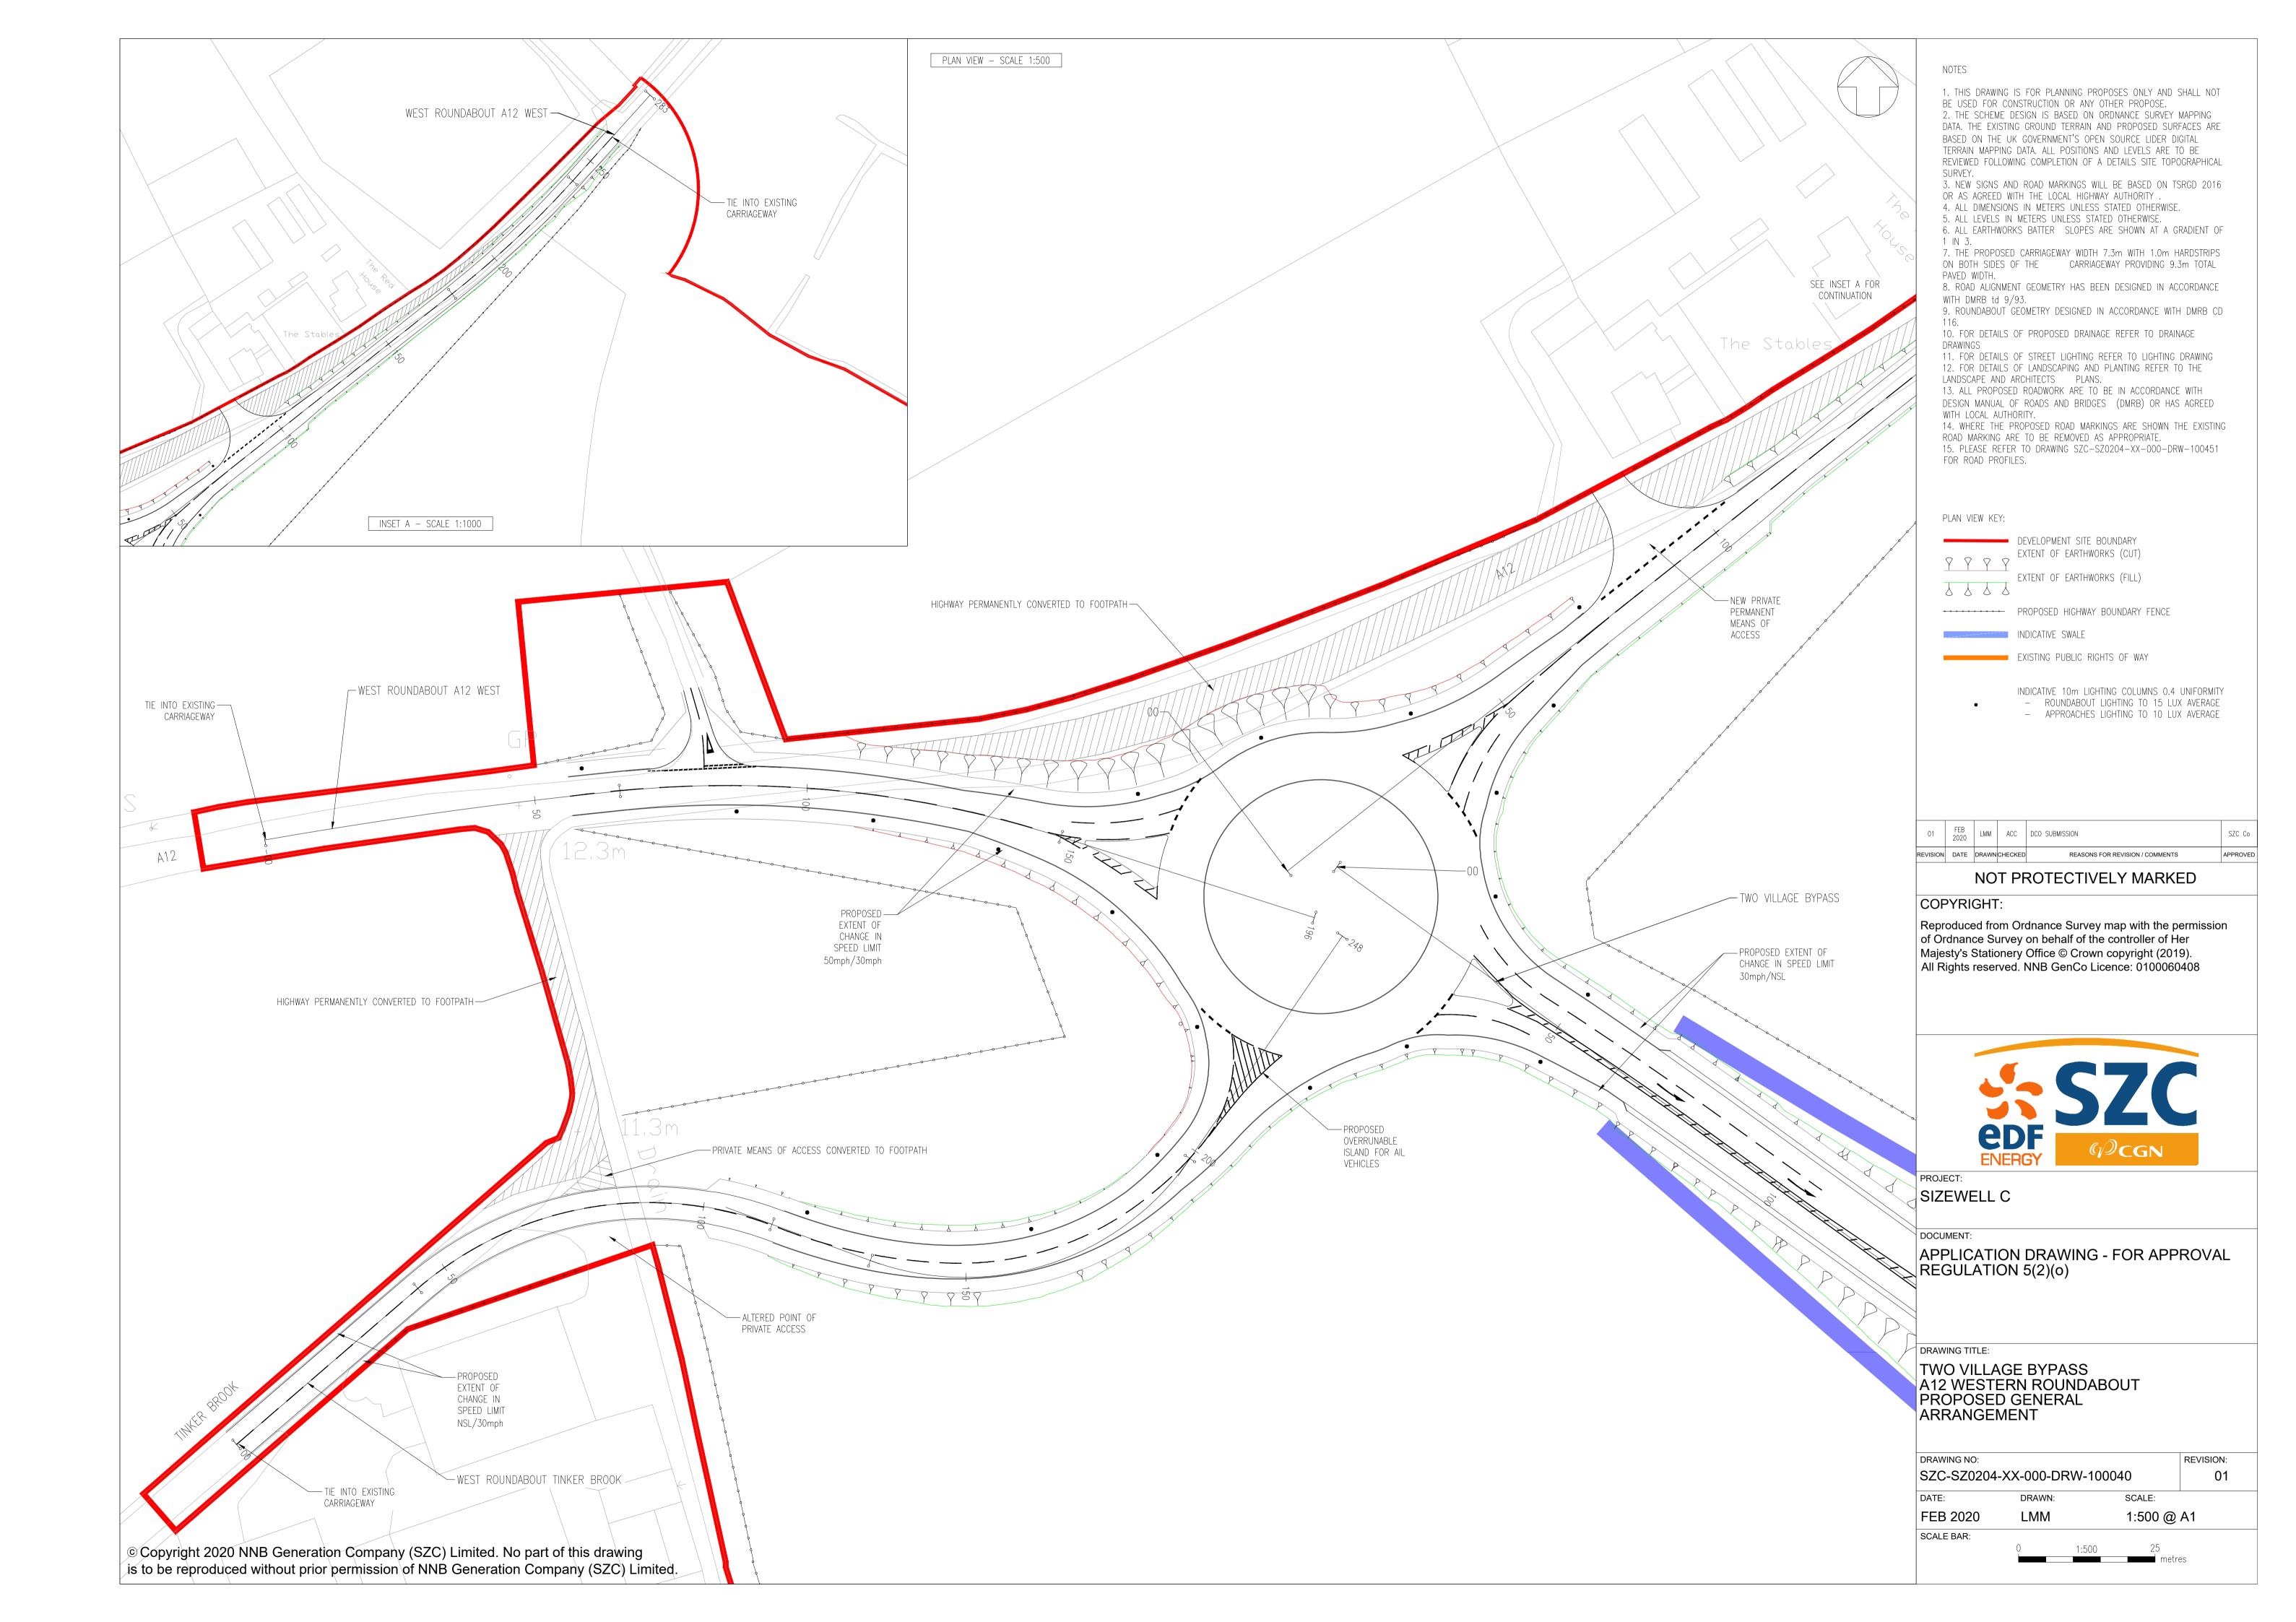


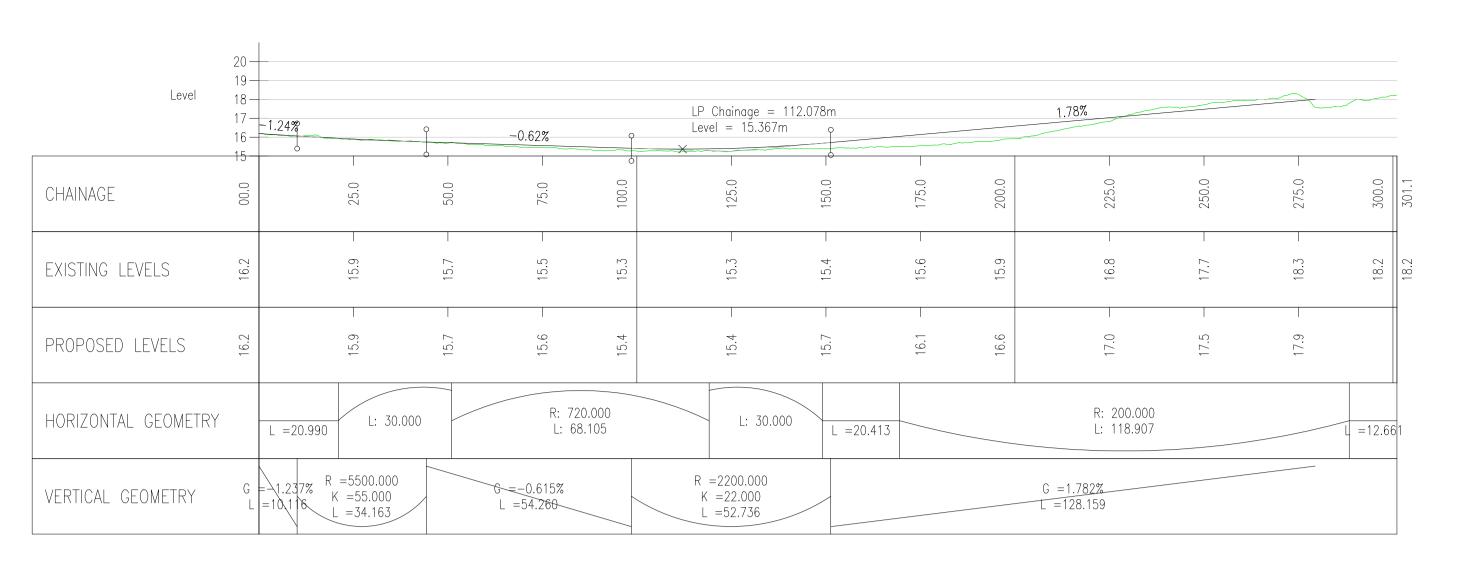

EAST ROUNDABOUT A12 EAST SCALE: H 1:1000,V 1:200. DATUM: 15.000

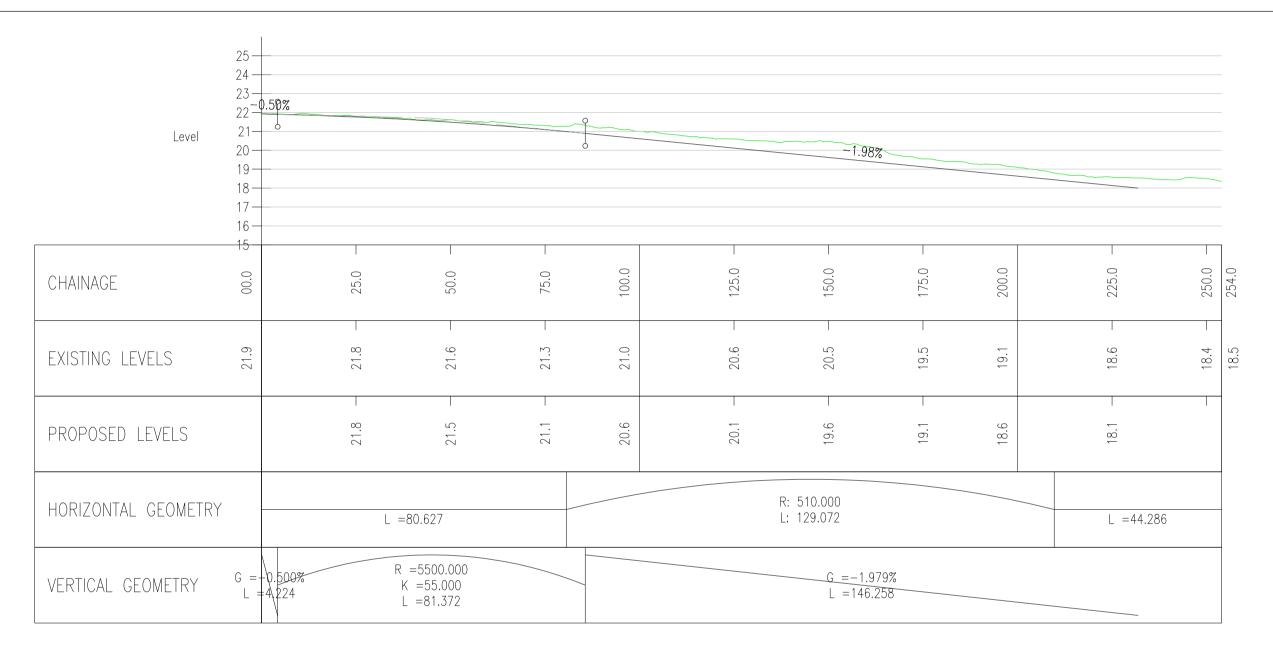

EAST ROUNDABOUT A12 WEST SCALE: H 1:1000,V 1:200. DATUM: 15.000

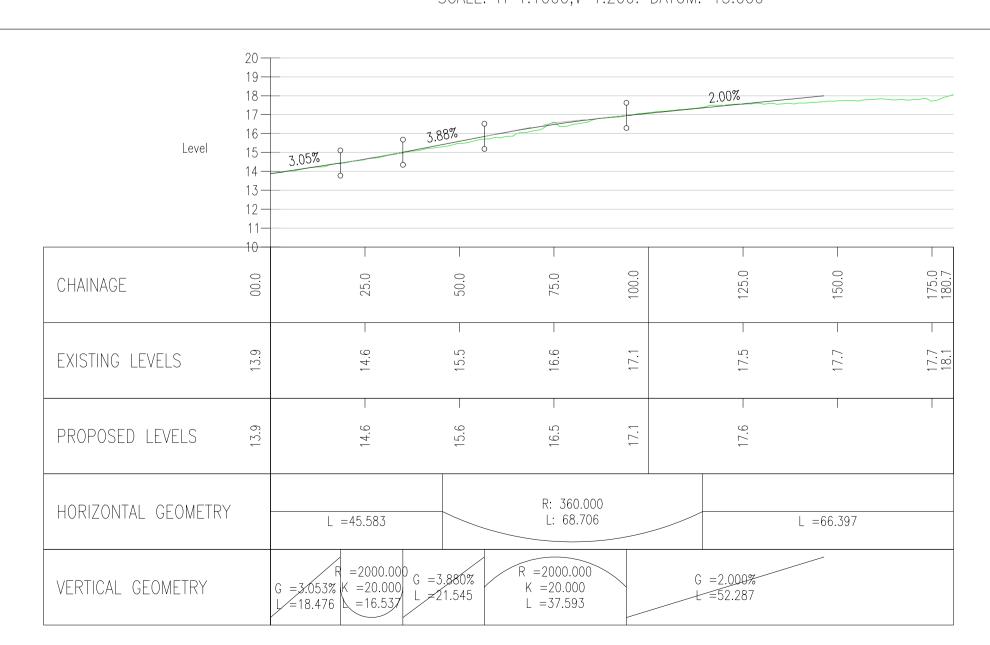

EAST ROUNDABOUT A1094 SCALE: H 1:1000,V 1:200. DATUM: 10.000

#### NOTES:

- 1. THIS DRAWING IS FOR PLANNING PURPOSES ONLY AND SHALL NOT BE USED FOR CONSTRUCTION OR ANY OTHER PURPOSE.
- 2. ALL DIMENSIONS ARE IN METRES UNLESS STATED OTHERWISE.
- 3. ALL LEVELS ARE IN METRES UNLESS STATED OTHERWISE. 4. FOR CROSS SECTION LOCATIONS REFER TO THE GENERAL
- ARRANGEMENT DRAWING SZC-SZ0204-XX-00-DRW-100039. 5. THE SCHEME DESIGN IS BASED ON ORDNANCE SURVEY MAPPING DATA. THE EXISTING GROUND TERRAIN AND PROPOSED SURFACES ARE BASED ON THE UK GOVERNMENT'S OPEN SOURCE LIDAR DIGITAL TERRAIN MAPPING DATA. ALL POSITIONS AND LEVELS ARE TO BE REVIEWED FOLLOWING COMPLETION OF A DETAILED SITE TOPOGRAPHICAL SURVEY.
- 6. ALL PROPOSED ROAD WORKS ARE TO BE IN ACCORDANCE WITH THE DESIGN MANUAL FOR ROADS AND BRIDGES (DMRB) OR AS AGREED WITH THE LOCAL HIGHWAY AUTHORITY.
- 7. NEW SIGNS AND ROAD MARKINGS WILL BE BASED ON TSRGD 2016 OR AS AGREED WITH THE LOCAL HIGHWAY AUTHORITY.
- 8. ALL EARTHWORKS BATTER SLOPES ARE SHOWN AT A GRADIENT
- 9. ROAD ALIGNMENT GEOMETRY HAS BEEN DESIGNED IN ACCORDANCE WITH DMRB TD 9/93.
- 10. ROUNDABOUT GEOMETRY DESIGNED IN ACCORDANCE WITH DMRB CD 116.

#### PROFILE VIEW KEY:

---- EXISTING GROUND LEVEL

1 FEB 2020 LMM ACC DCO SUBMISSION SZC	SION	DATE	DRAWN	CHECKED	REASONS FOR REVISION / COMMENTS	APPROVI
	1		LMM	ACC	DCO SUBMISSION	SZC Co

## NOT PROTECTIVELY MARKED

#### COPYRIGHT:

Reproduced from Ordnance Survey map with the permission of Ordnance Survey on behalf of the controller of Her Majesty's Stationery Office © Crown copyright (2019).
All Rights reserved. NNB GenCo Licence: 0100060408



SIZEWELL C

APPLICATION DRAWING - FOR APPROVAL REGULATION 5(2)(o)


#### DRAWING TITLE:

TWO VILLAGE BYPASS A12/A1094 EASTERN ROUNDABOUT PROPOSED PROFILES


DRAWING NO:			REVISION:
SZC-SZ0204	01		
DATE:	DRAWN:	SCALE:	
FEB 2020	LMM	AS SHOW	VN @ A1
SCALE BAR:			
	0	1:1000 50	

## Level CHAINAGE EXISTING LEVELS PROPOSED LEVELS R: 900.000 R: 200.000 HORIZONTAL GEOMETRY L: 65.646 L: 81.783 L = 48.718G =-1.693% G = -1.800%VERTICAL GEOMETRY K = 100.000 L =39.222 L = 115.403

WEST ROUNDABOUT A12 WEST SCALE: H 1:1000,V 1:200. DATUM: 5.000

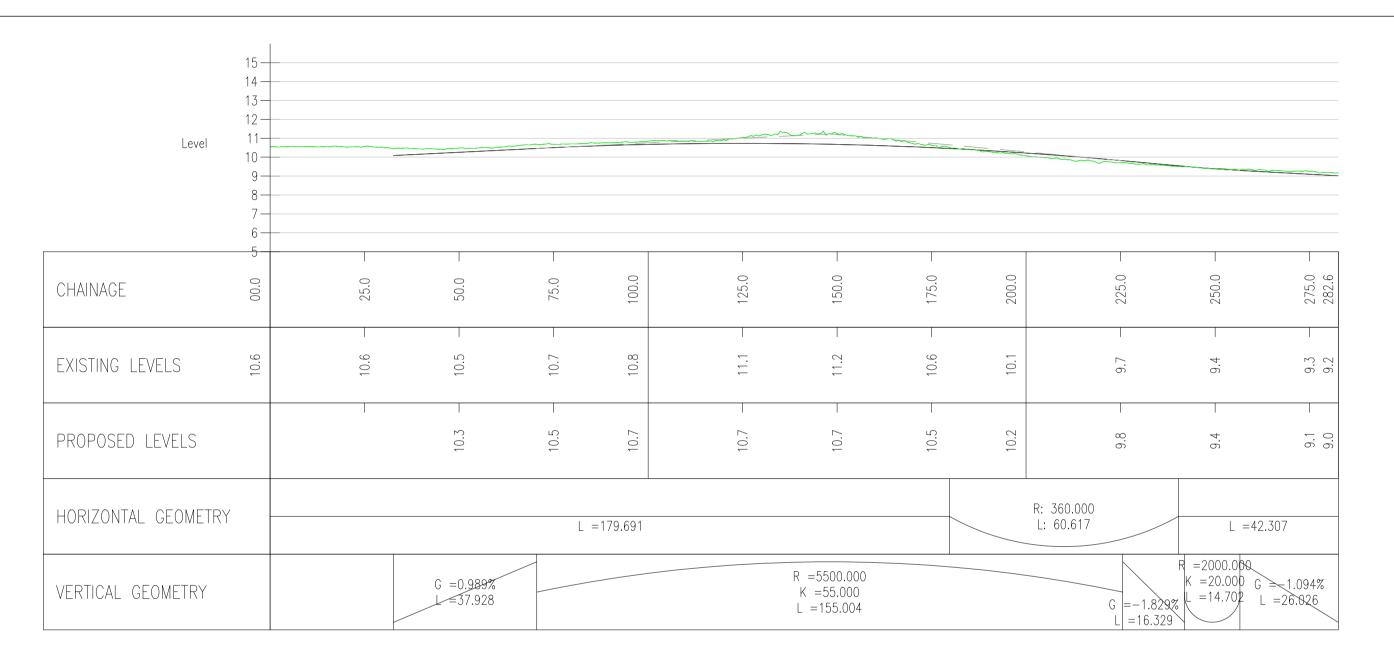

WEST ROUNDABOUT A12 EAST SCALE: H 1:1000,V 1:200. DATUM: 5.000

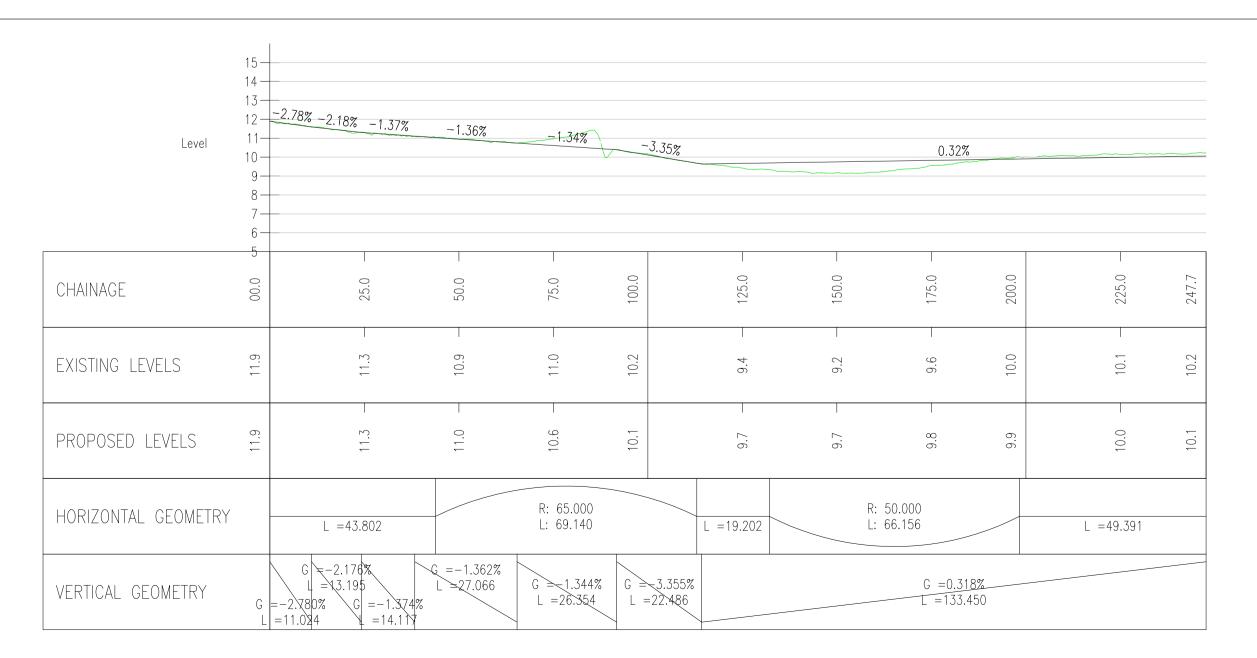

WEST ROUNDABOUT TINKER BROOK

#### NOTES:

- 1. THIS DRAWING IS FOR PLANNING PURPOSES ONLY AND SHALL NOT BE USED FOR CONSTRUCTION OR ANY OTHER PURPOSE.
- 2. ALL DIMENSIONS ARE IN METRES UNLESS STATED OTHERWISE.
- 3. ALL LEVELS ARE IN METRES UNLESS STATED OTHERWISE. 4. FOR CROSS SECTION LOCATIONS REFER TO THE GENERAL
- ARRANGEMENT DRAWING SZC-SZ0204-XX-00-DRW-100040. 5. THE SCHEME DESIGN IS BASED ON ORDNANCE SURVEY MAPPING DATA. THE EXISTING GROUND TERRAIN AND PROPOSED SURFACES ARE BASED ON THE UK GOVERNMENT'S OPEN SOURCE LIDAR DIGITAL TERRAIN MAPPING DATA. ALL POSITIONS
- AND LEVELS ARE TO BE REVIEWED FOLLOWING COMPLETION OF A DETAILED SITE TOPOGRAPHICAL SURVEY. 6. ALL PROPOSED ROAD WORKS ARE TO BE IN ACCORDANCE WITH
- THE DESIGN MANUAL FOR ROADS AND BRIDGES (DMRB) OR AS AGREED WITH THE LOCAL HIGHWAY AUTHORITY. 7. NEW SIGNS AND ROAD MARKINGS WILL BE BASED ON TSRGD
- 2016 OR AS AGREED WITH THE LOCAL HIGHWAY AUTHORITY. 8. ALL EARTHWORKS BATTER SLOPES ARE SHOWN AT A GRADIENT
- 9. ROAD ALIGNMENT GEOMETRY HAS BEEN DESIGNED IN
- ACCORDANCE WITH DMRB TD 9/93. 10. ROUNDABOUT GEOMETRY DESIGNED IN ACCORDANCE WITH DMRB CD 116.

#### PROFILE VIEW KEY:

---- EXISTING GROUND LEVEL

01 FEB LMM ACC DCO SUBMISSION SZC Co REVISION DATE DRAWN CHECKED REASONS FOR REVISION / COMMENTS APPROVED

## NOT PROTECTIVELY MARKED

#### COPYRIGHT:

Reproduced from Ordnance Survey map with the permission of Ordnance Survey on behalf of the controller of Her Majesty's Stationery Office © Crown copyright (2019).
All Rights reserved. NNB GenCo Licence: 0100060408



SIZEWELL C

APPLICATION DRAWING - FOR APPROVAL REGULATION 5(2)(o)

DRAWING TITLE:

DRAWING NO:


SCALE BAR:


TWO VILLAGE BYPASS A12 WESTERN ROUNDABOUT PROPOSED PROFILES


SZC-SZ0204-XX-000-DRW-100451 01 DATE: DRAWN: SCALE: AS SHOWN @ A1 FEB 2020 LMM

REVISION:

© Copyright 2020 NNB Generation Company (SZC) Limited. No part of this drawing is to be reproduced without prior permission of NNB Generation Company (SZC) Limited. SCALE: H 1:1000,V 1:200. DATUM: 5.000

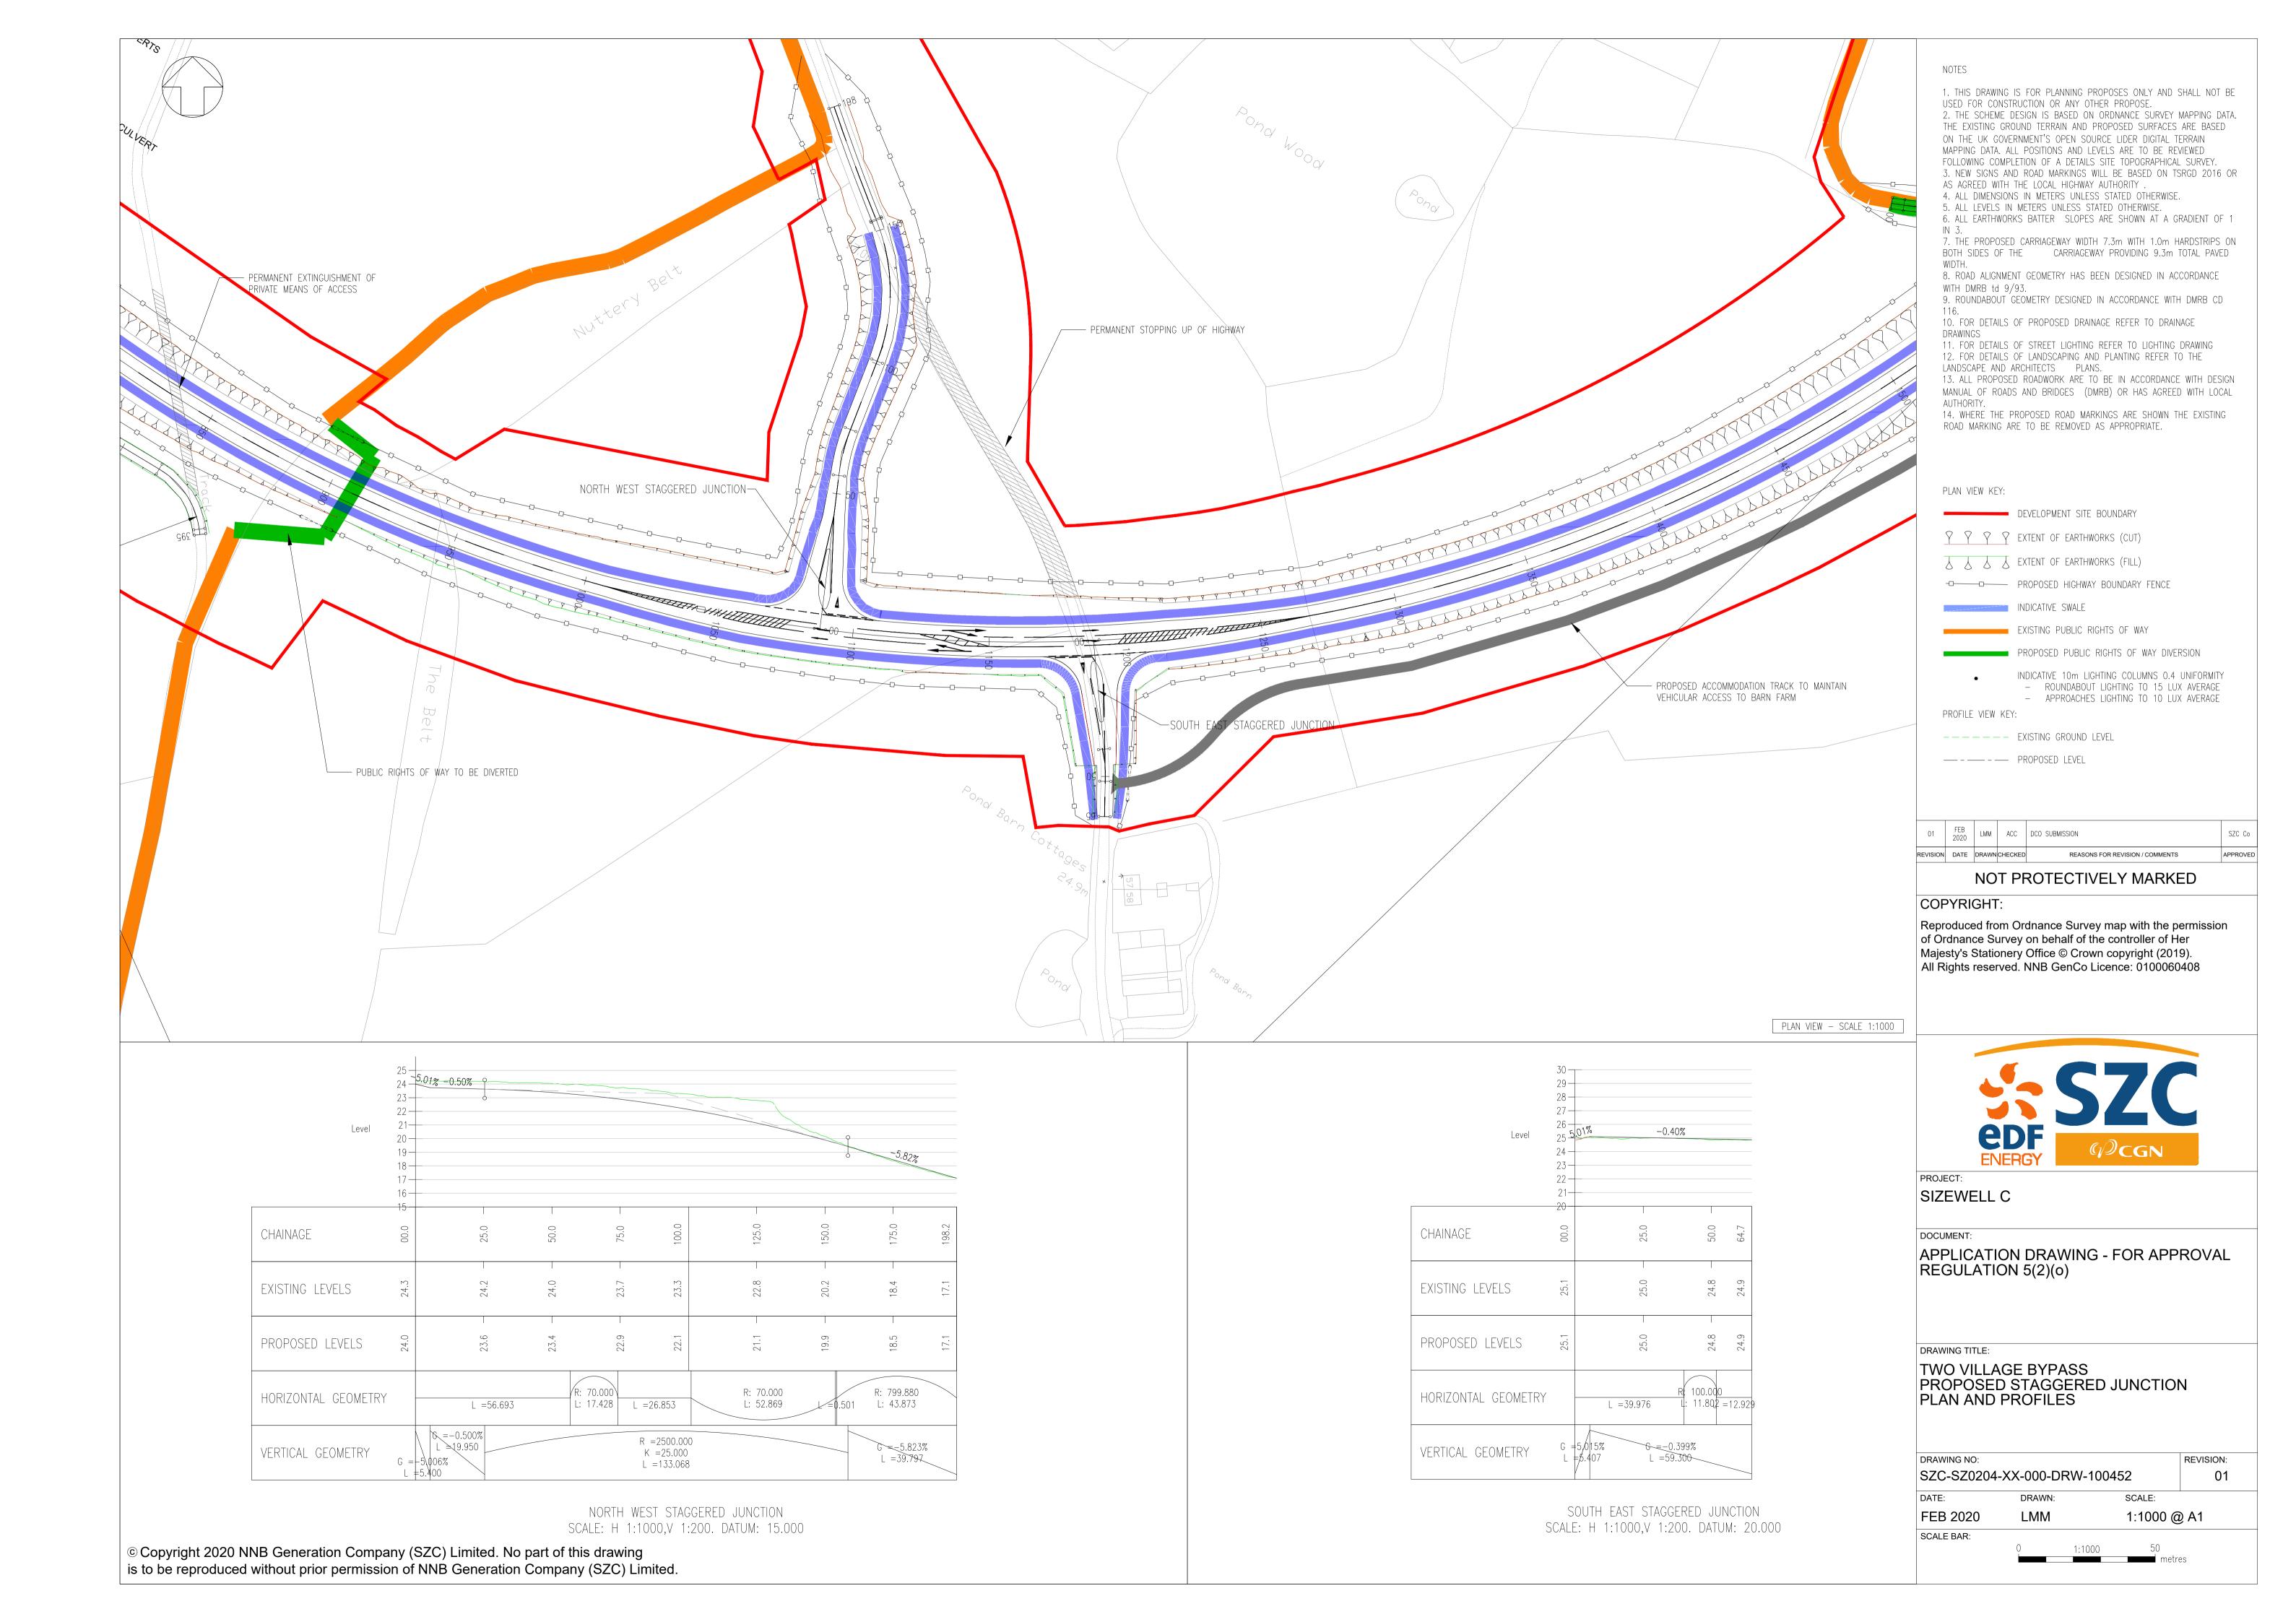


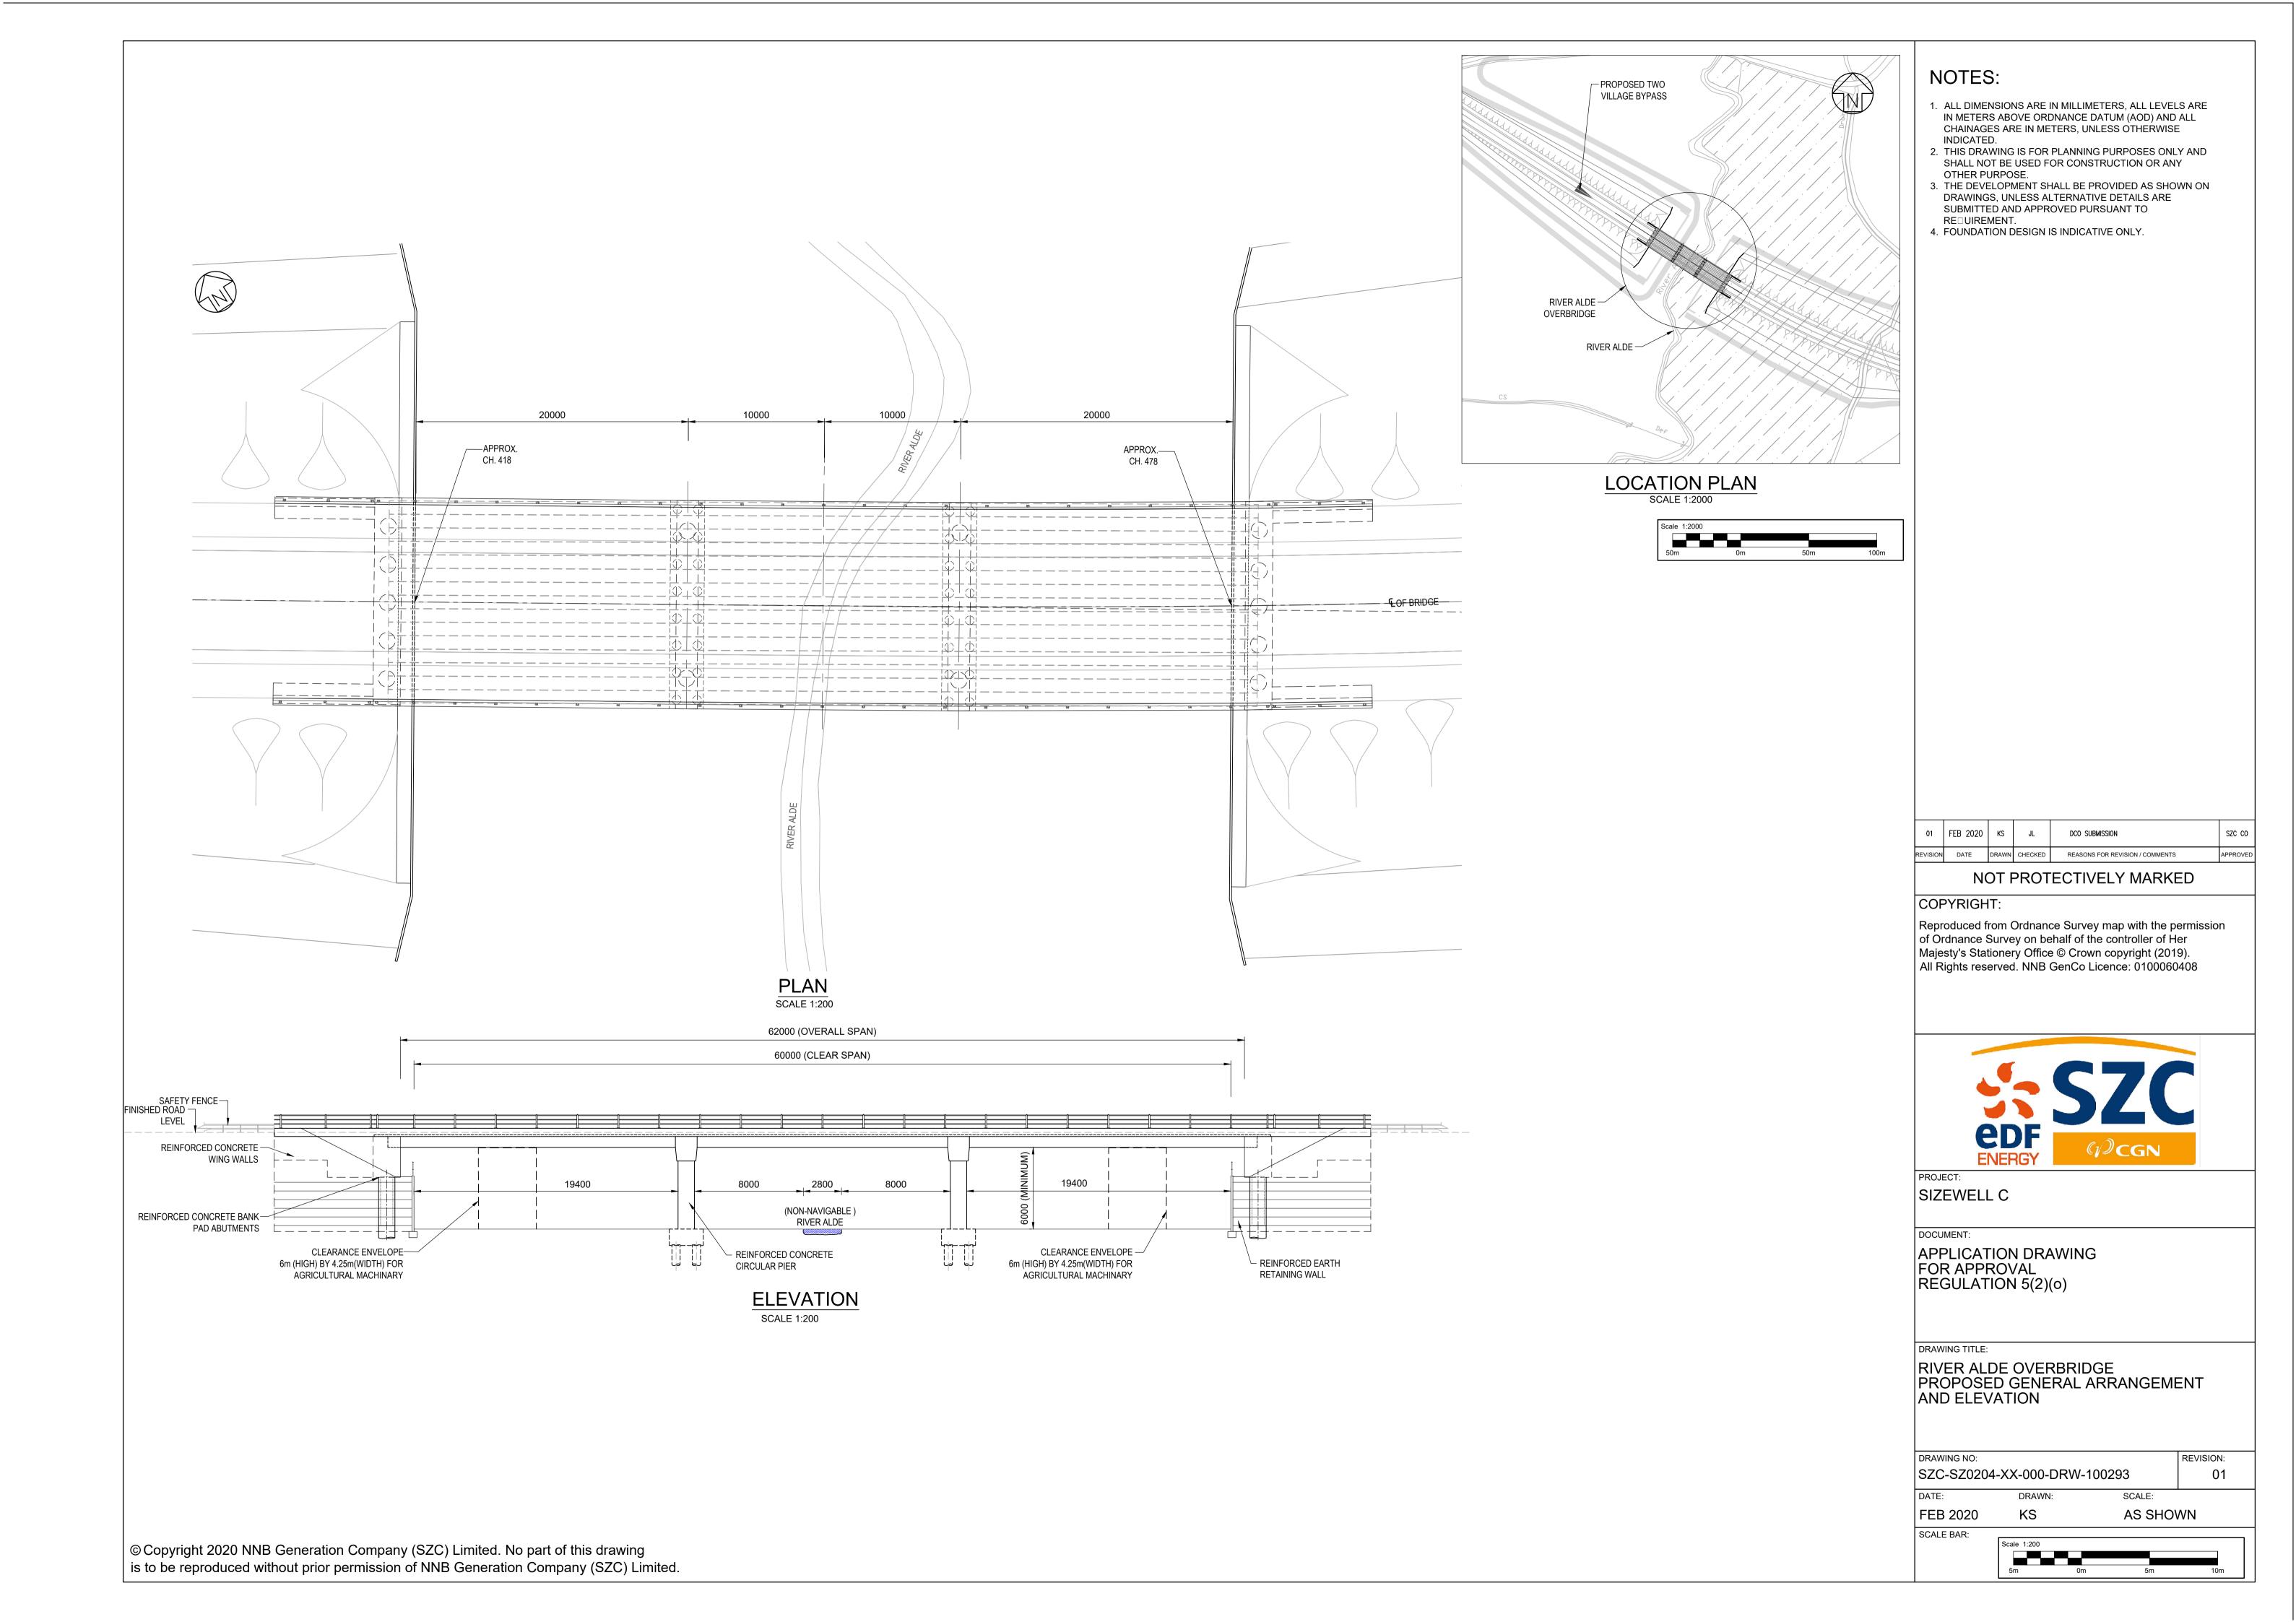

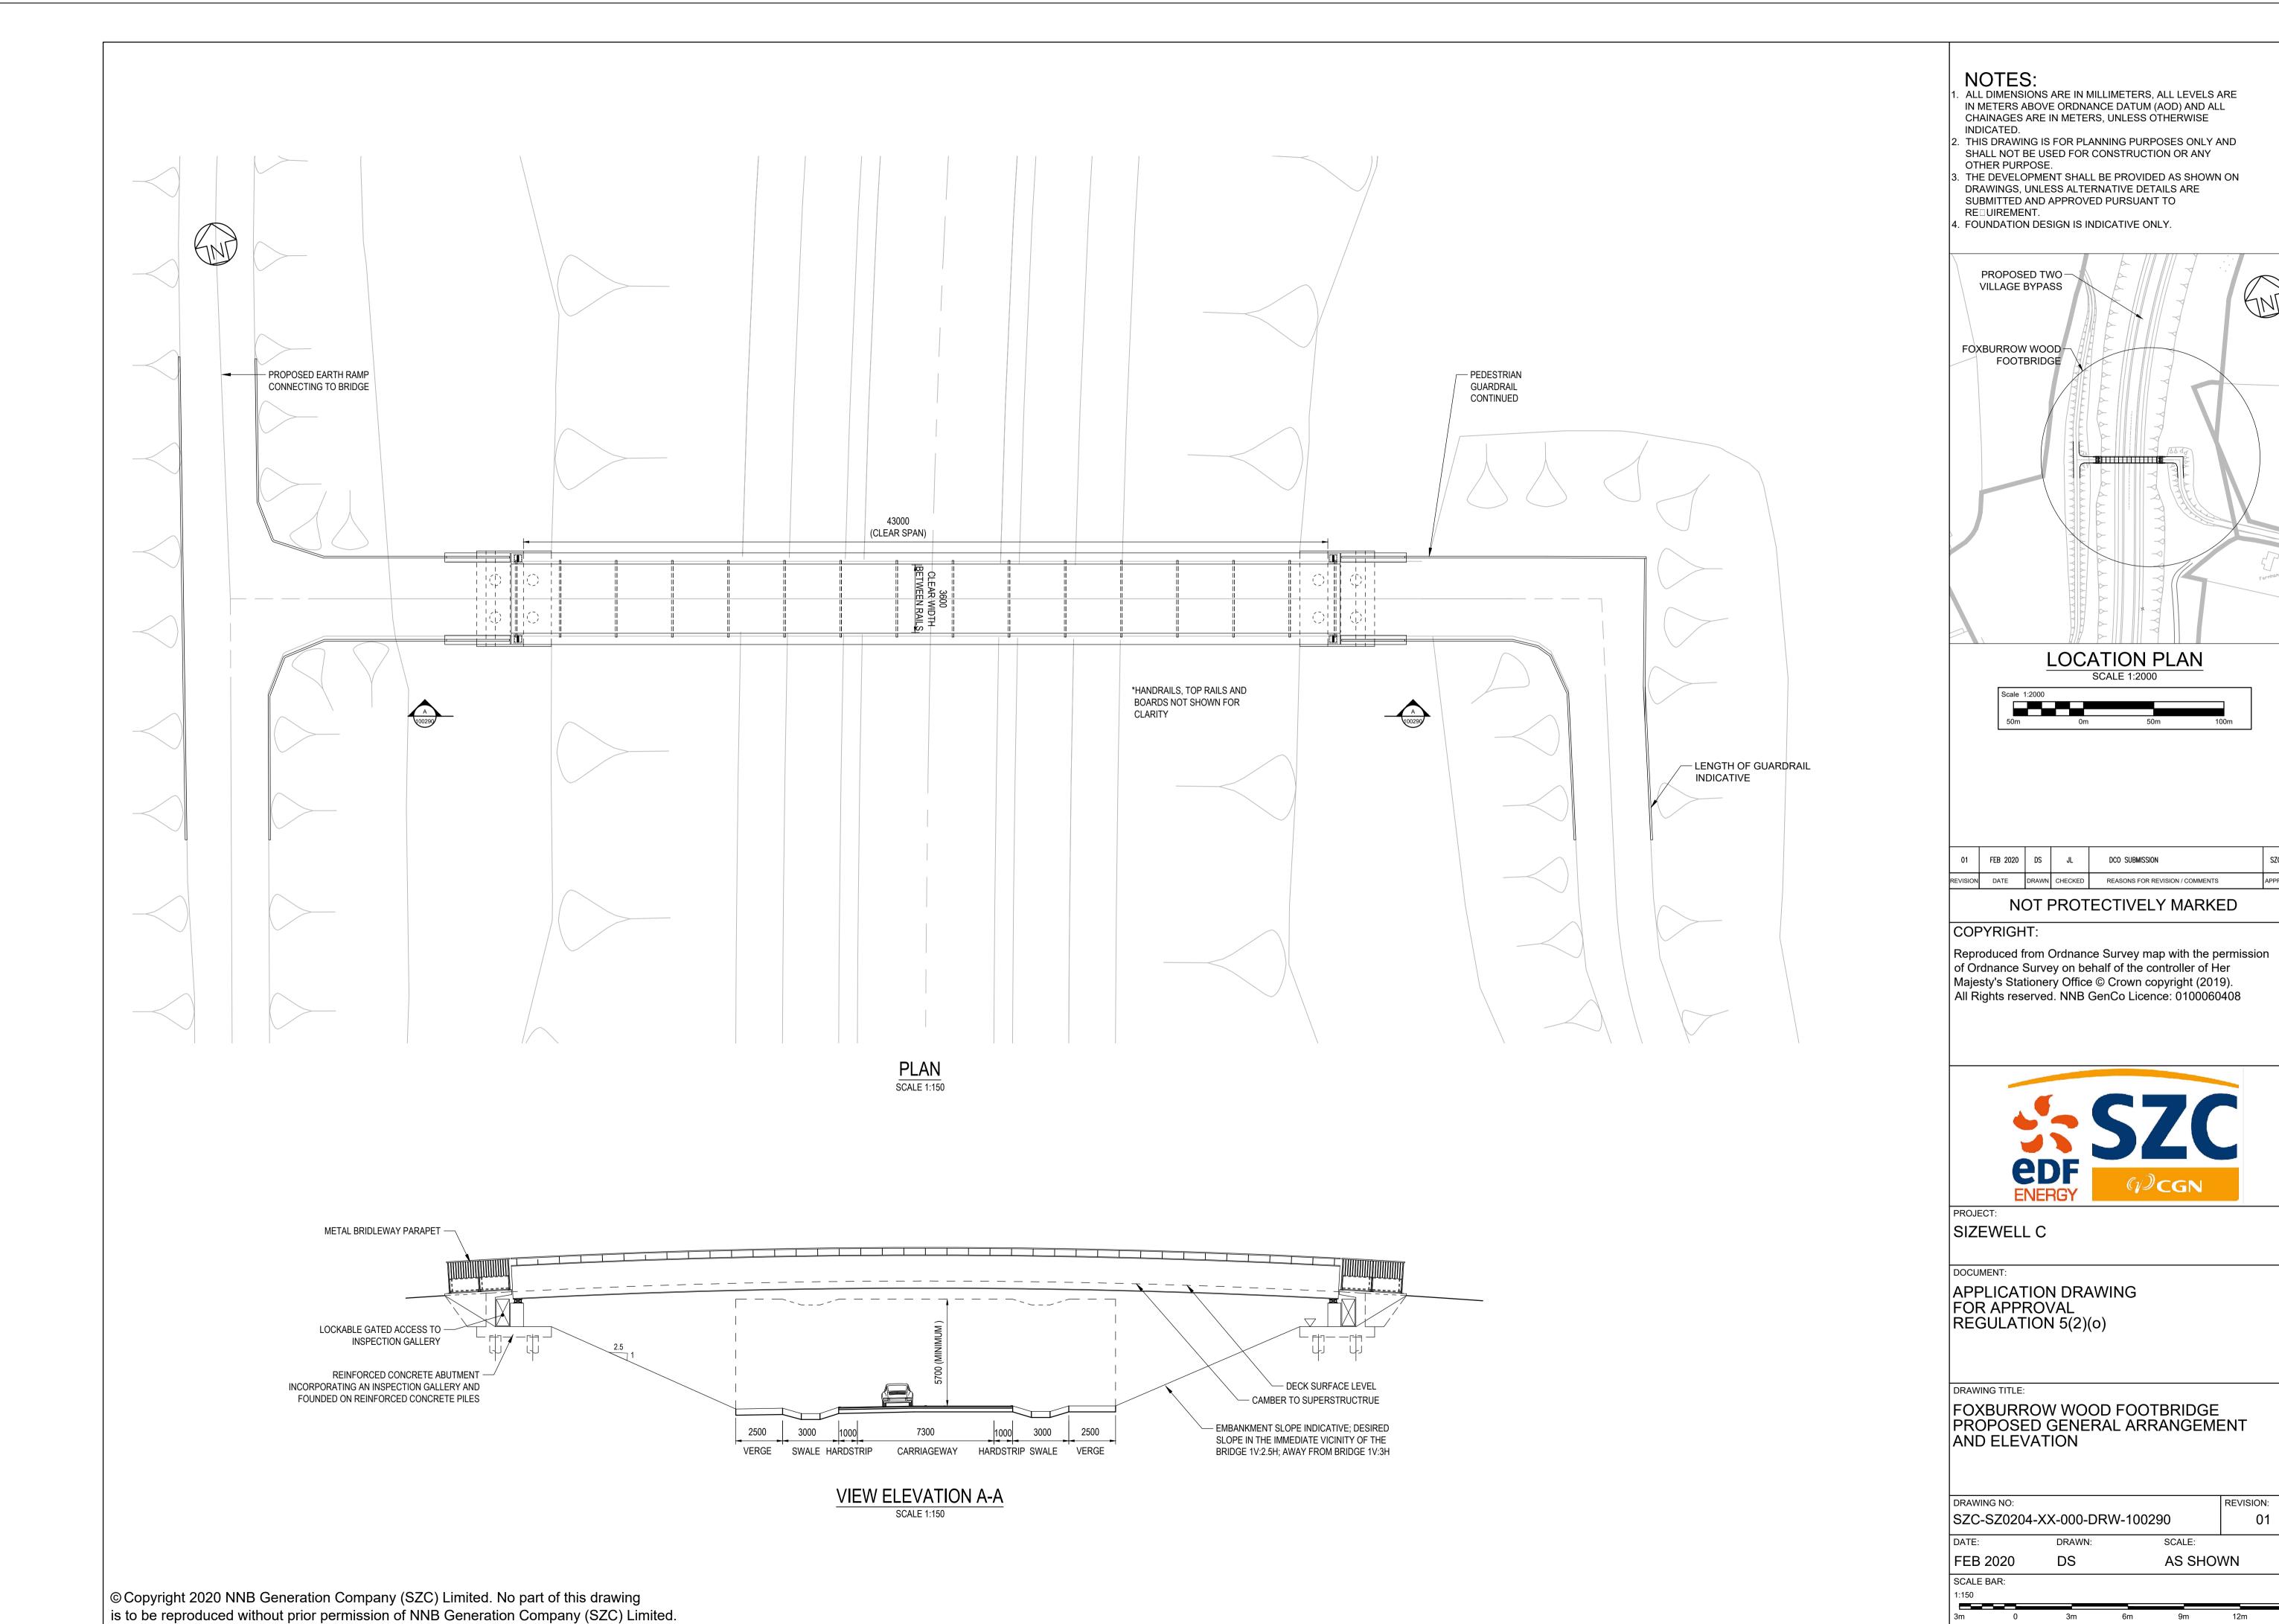


SZC CO


01

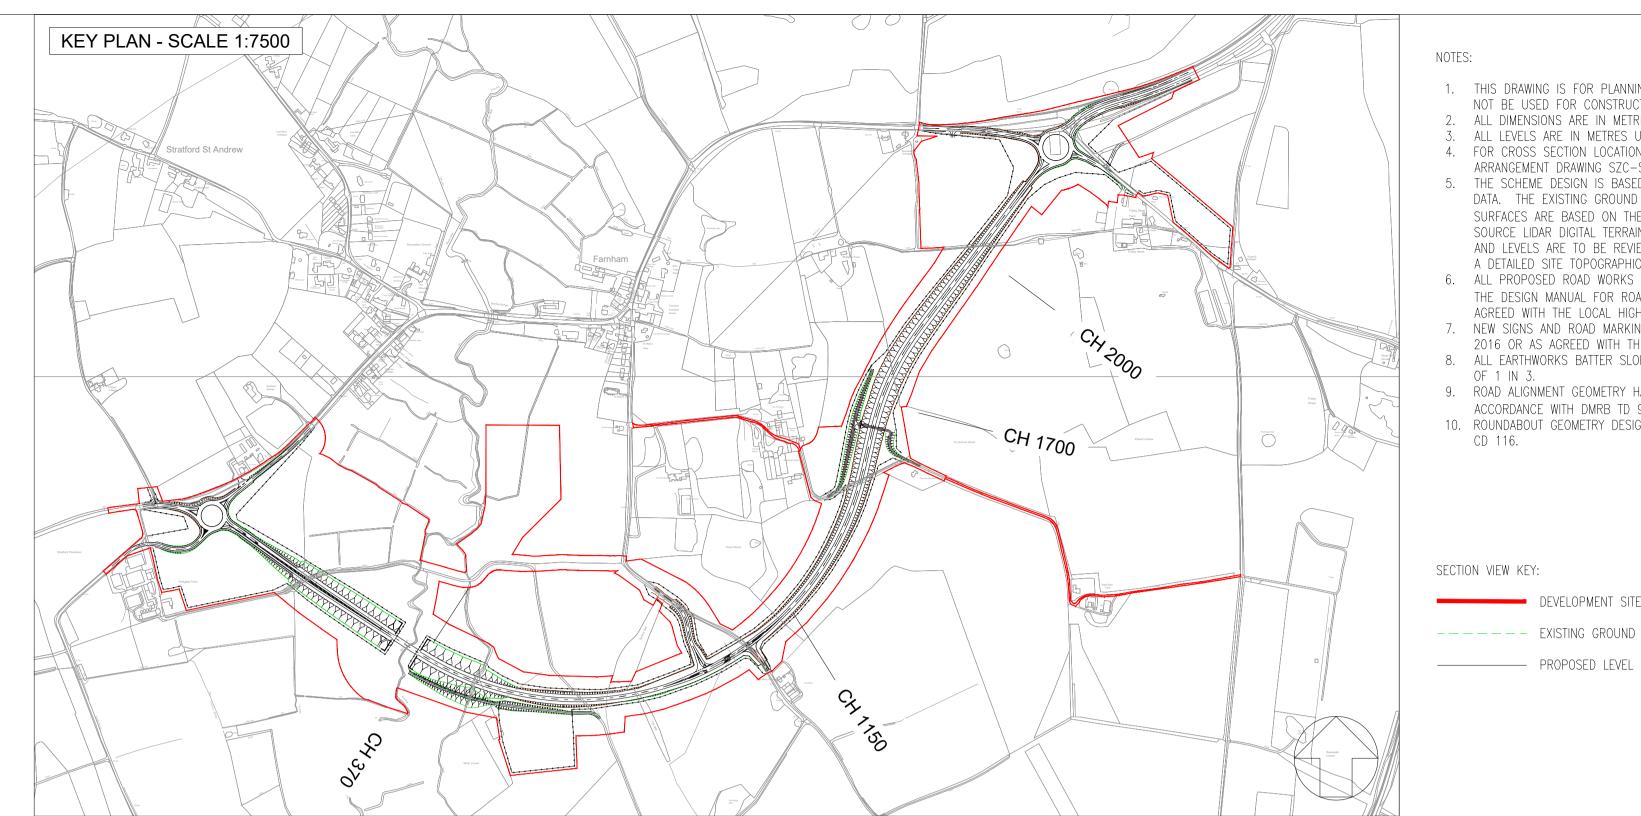



- 1. THIS DRAWING IS FOR PLANNING PURPOSES ONLY AND SHALL NOT BE USED FOR CONSTRUCTION OR ANY OTHER PURPOSE.
- 2. ALL DIMENSIONS ARE IN METRES UNLESS STATED OTHERWISE.
- 3. ALL LEVELS ARE IN METRES UNLESS STATED OTHERWISE. 4. FOR CROSS SECTION LOCATIONS REFER TO THE GENERAL ARRANGEMENT DRAWING SZC-SZ0204-XX-00-DRW-100443.
- 5. THE SCHEME DESIGN IS BASED ON ORDNANCE SURVEY MAPPING DATA. THE EXISTING GROUND TERRAIN AND PROPOSED SURFACES ARE BASED ON THE UK GOVERNMENT'S OPEN SOURCE LIDAR DIGITAL TERRAIN MAPPING DATA. ALL POSITIONS AND LEVELS ARE TO BE REVIEWED FOLLOWING COMPLETION OF A DETAILED SITE TOPOGRAPHICAL SURVEY.
- 6. ALL PROPOSED ROAD WORKS ARE TO BE IN ACCORDANCE WITH THE DESIGN MANUAL FOR ROADS AND BRIDGES (DMRB) OR AS AGREED WITH THE LOCAL HIGHWAY AUTHORITY.
- 7. NEW SIGNS AND ROAD MARKINGS WILL BE BASED ON TSRGD 2016 OR AS AGREED WITH THE LOCAL HIGHWAY AUTHORITY.
- 8. ALL EARTHWORKS BATTER SLOPES ARE SHOWN AT A GRADIENT
- 9. ROAD ALIGNMENT GEOMETRY HAS BEEN DESIGNED IN ACCORDANCE WITH DMRB TD 9/93.
- 10. ROUNDABOUT GEOMETRY DESIGNED IN ACCORDANCE WITH DMRB CD 116.



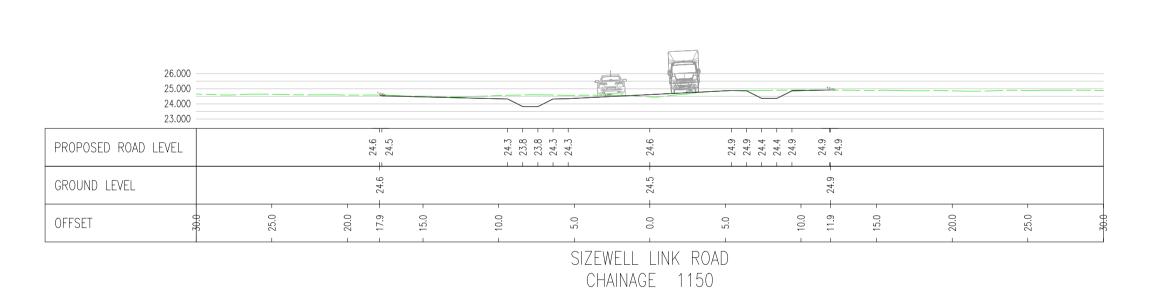

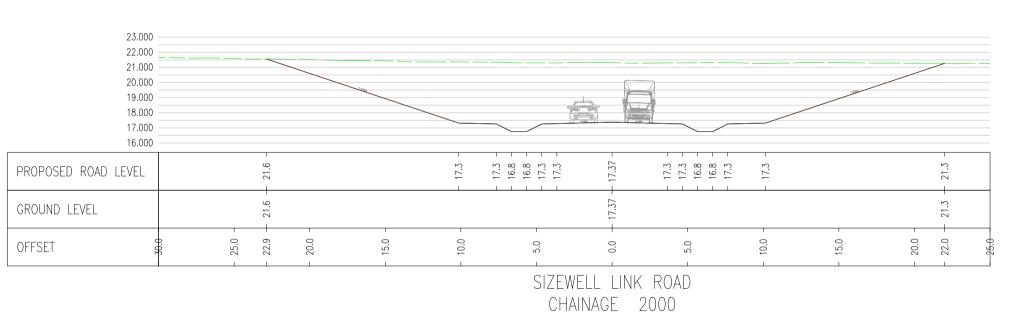

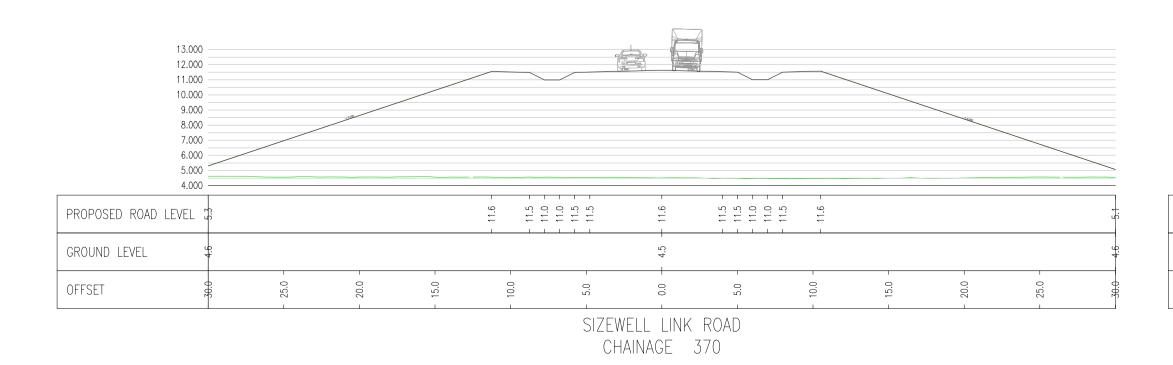

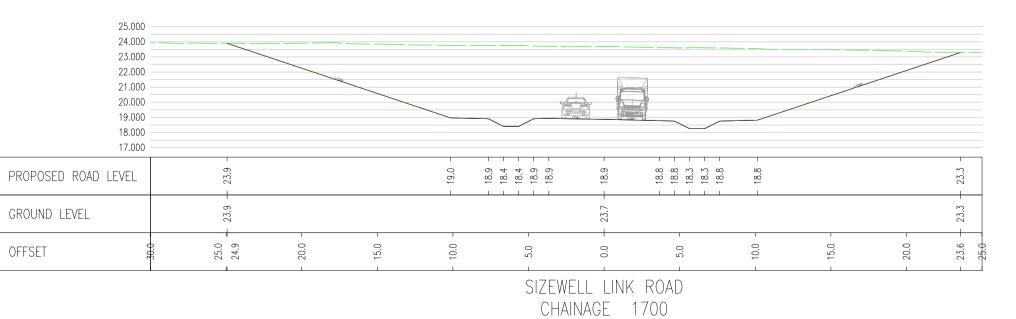

01 FEB MSF ACC DCO SUBMISSION REVISION DATE DRAWN CHECKED REASONS FOR REVISION / COMMENTS

## NOT PROTECTIVELY MARKED

#### COPYRIGHT:

Reproduced from Ordnance Survey map with the permission of Ordnance Survey on behalf of the controller of Her Majesty's Stationery Office © Crown copyright (2019). All Rights reserved. NNB GenCo Licence: 0100060408



SIZEWELL C

APPLICATION DRAWING -NOT FOR APPROVAL REGULATION 5(2)(0)

DRAWING TITLE:

TWO VILLAGE BYPASS CROSS SECTIONS

DRAWING NO:	REVISION:			
SZC-SZ0204-X	01			
DATE:	DRAWN:	SCALE		
FEB 2020 MSF 1:250 @			A1	
SCALE BAR:				
	0	1:250 12	.5 I metre	28

# - PROPOSED EARTH RAMP — PEDESTRIAN CONNECTING TO BRIDGE GUARDRAIL CONTINUED 43000 (CLEAR SPAN) \*HANDRAILS, TOP RAILS AND BOARDS NOT SHOWN FOR CLARITY - LENGTH OF GUARDRAIL INDICATIVE PLAN SCALE 1:150

#### NOTES:

- ALL DIMENSIONS ARE IN MILLIMETERS, ALL LEVELS ARE IN METERS ABOVE ORDNANCE DATUM (AOD) AND ALL CHAINAGES ARE IN METERS, UNLESS OTHERWISE INDICATED.
- . THIS DRAWING IS FOR PLANNING PURPOSES ONLY AND SHALL NOT BE USED FOR CONSTRUCTION OR ANY OTHER PURPOSE.
- . THE DEVELOPMENT SHALL BE PROVIDED AS SHOWN ON DRAWINGS, UNLESS ALTERNATIVE DETAILS ARE SUBMITTED AND APPROVED PURSUANT TO RE UIREMENT.
- FOUNDATION DESIGN IS INDICATIVE ONLY.
- DRAWING TO BE READ IN CONJUNCTION WITH DRAWING 100290, 100292 AND OTHER SCHEME DRAWINGS.

#### SZC CO FEB 2020 DS JL DCO SUBMISSION REASONS FOR REVISION / COMMENTS

## NOT PROTECTIVELY MARKED

#### COPYRIGHT:

Reproduced from Ordnance Survey map with the permission of Ordnance Survey on behalf of the controller of Her Majesty's Stationery Office © Crown copyright (2019). All Rights reserved. NNB GenCo Licence: 0100060408




SIZEWELL C

APPLICATION DRAWING NOT FOR APPROVAL REGULATION 5(2)(0)

FOXBURROW WOOD FOOTBRIDGE KEY PLAN FOR CROSS SECTIONS

DRAWING NO:						l:
SZC-SZ0204-XX-000-DRW-100291					0	1
DATE:		DRAWN:		SCALE:		
FEB 2020 DS AS SHOW				WN		
SCALE BA	AR:					
1:150						_
2m	0	3m	6m	0m	12m	15m

© Copyright 2020 NNB Generation Company (SZC) Limited. No part of this drawing is to be reproduced without prior permission of NNB Generation Company (SZC) Limited.

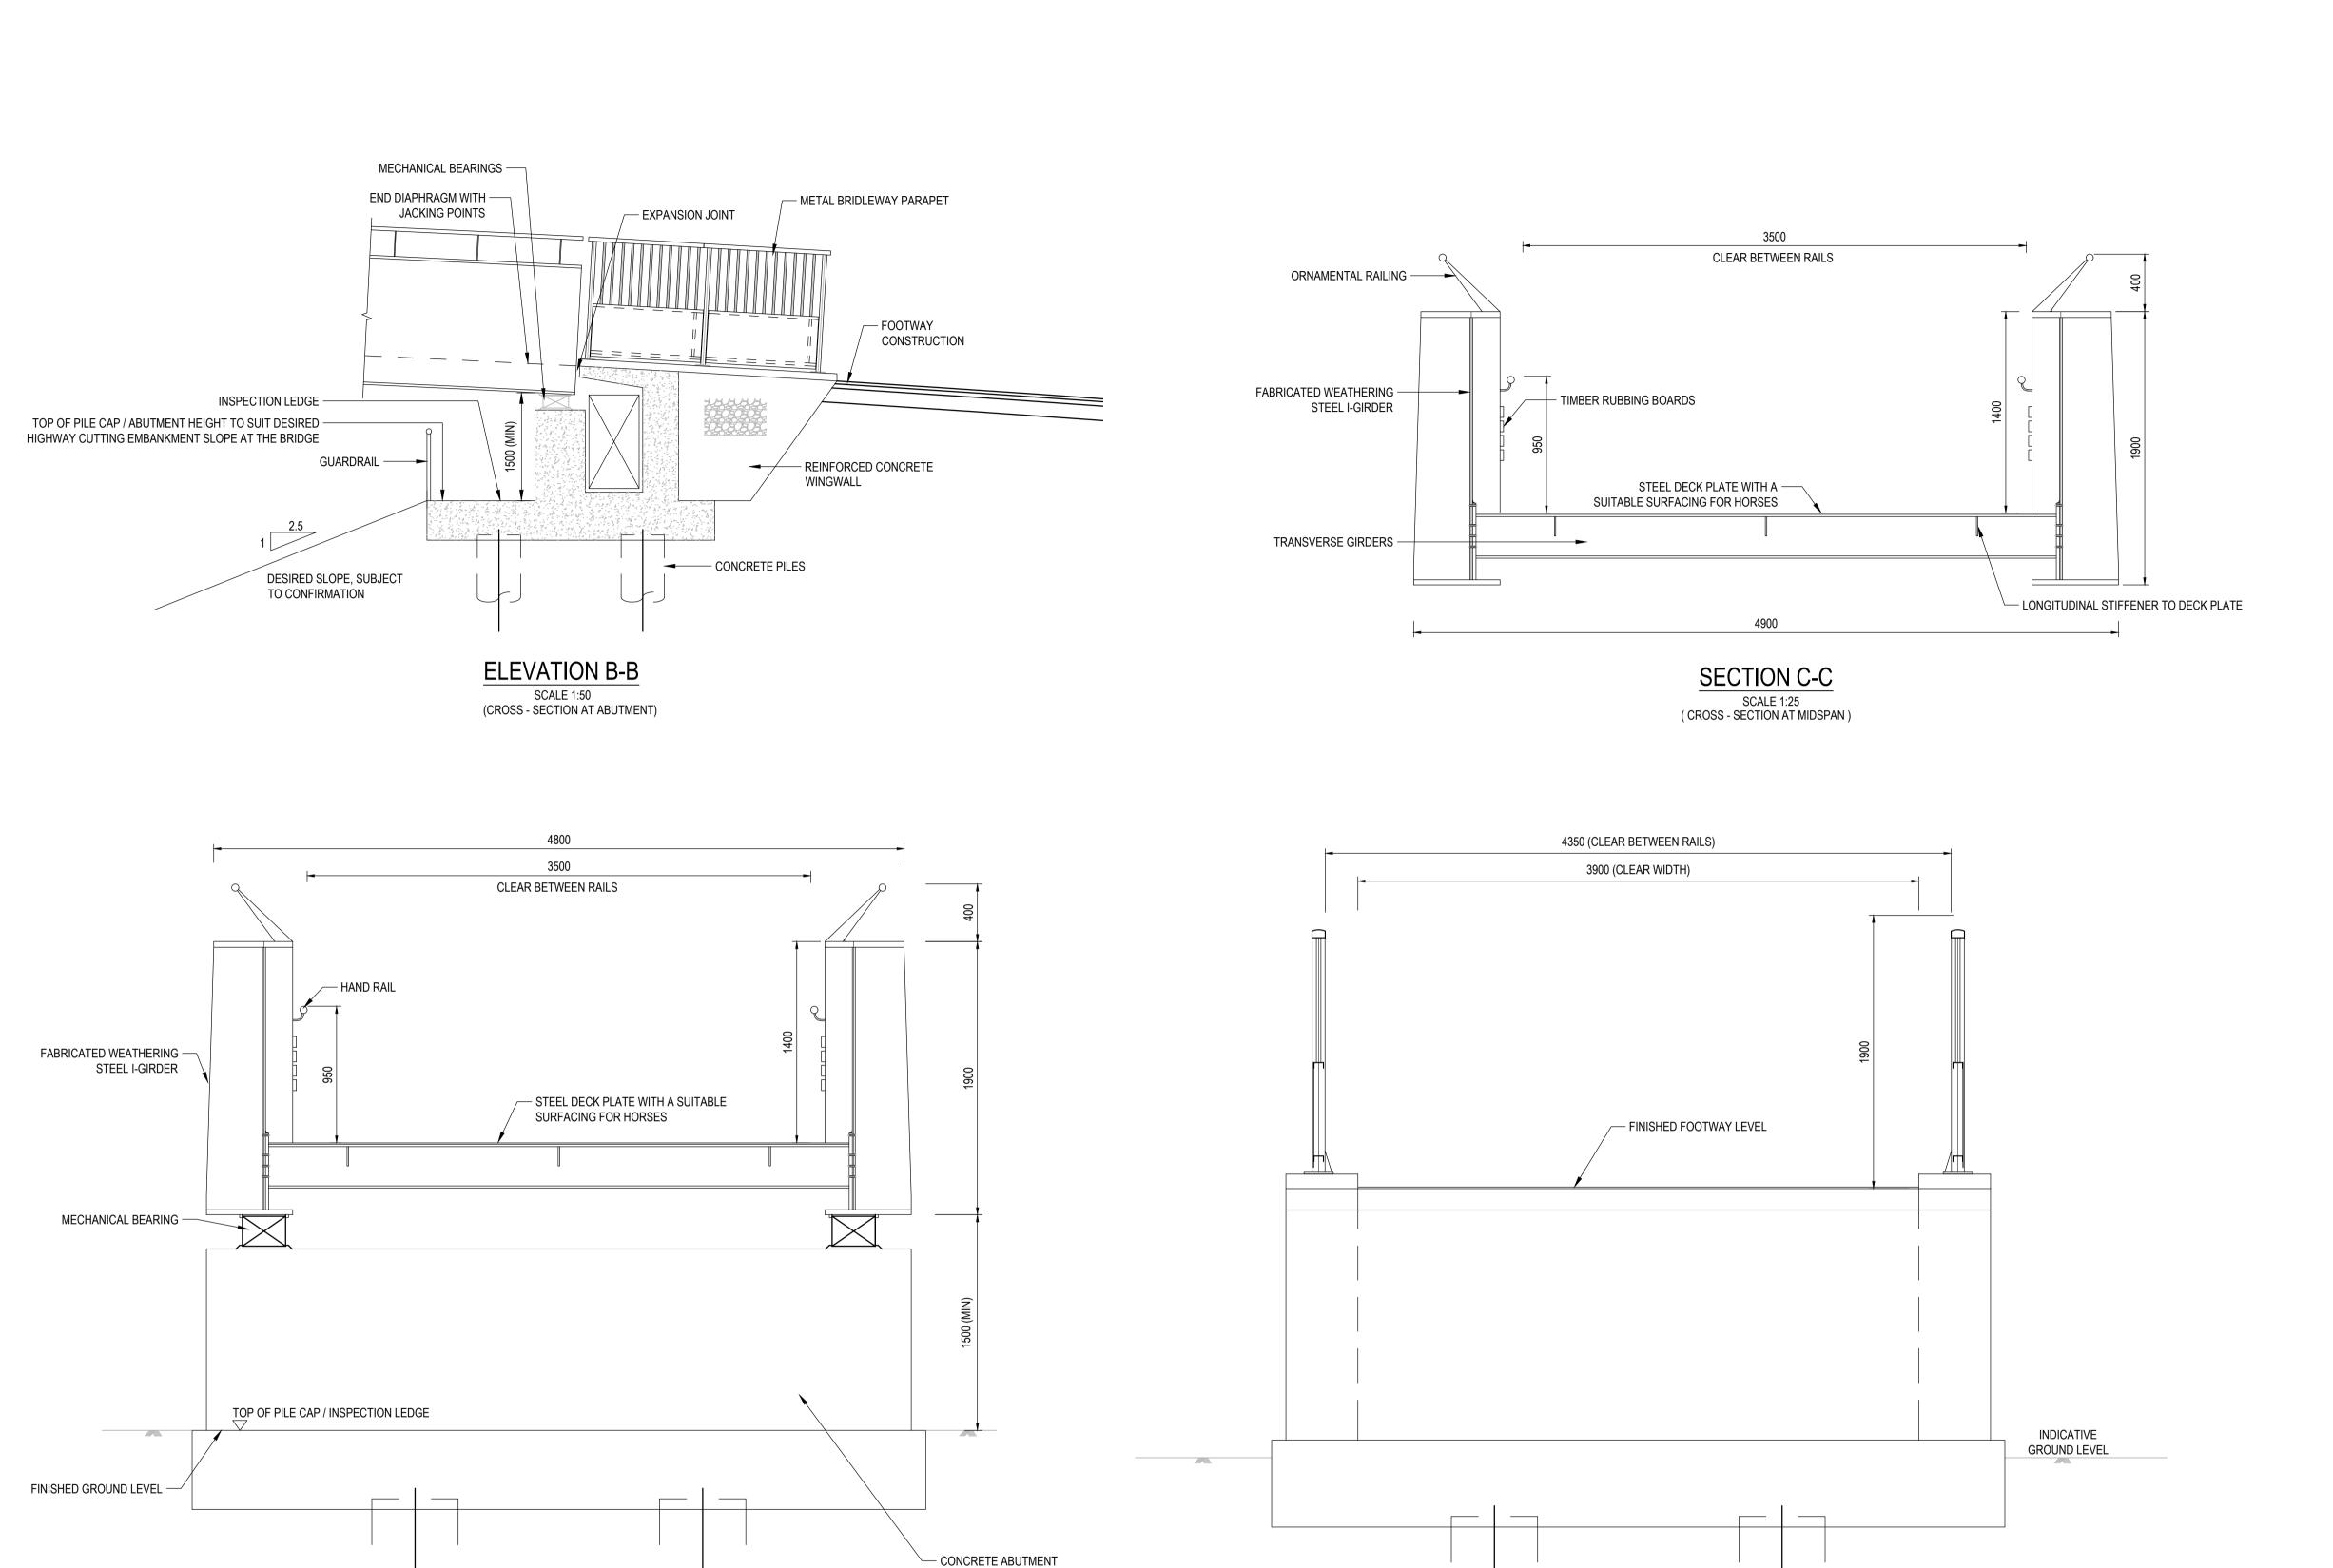

- CONCRETE PILES

- CONCRETE PILES

SECTION E-E

SCALE 1:25 ( CROSS - SECTION AT ABUTMENT

THROUGH INSPECTION GALLERY)

#### NOTES:

- ALL DIMENSIONS ARE IN MILLIMETERS, ALL LEVELS ARE IN METERS ABOVE ORDNANCE DATUM (AOD) AND ALL CHAINAGES ARE IN METERS, UNLESS OTHERWISE INDICATED.
- 2. THIS DRAWING IS FOR PLANNING PURPOSES ONLY AND SHALL NOT BE USED FOR CONSTRUCTION OR ANY OTHER
- PURPOSE.
  3. THE DEVELOPMENT SHALL BE PROVIDED AS SHOWN ON DRAWINGS, UNLESS ALTERNATIVE DETAILS ARE SUBMITTED
- AND APPROVED PURSUANT TO REQUIREMENT.

  4. FOUNDATION DESIGN IS INDICATIVE ONLY.

  5. DRAWING TO BE BEAD IN CONTUNICTION WITH DR
- 5. DRAWING TO BE READ IN CONJUNCTION WITH DRAWING 100290, 100291 AND OTHER SCHEME DRAWINGS.

NOT PROTECTIVELY MARKED

SZC CO

#### COPYRIGHT:

01 FEB 2020 DS

Reproduced from Ordnance Survey map with the permission of Ordnance Survey on behalf of the controller of Her Majesty's Stationery Office © Crown copyright (2019). All Rights reserved. NNB GenCo Licence: 0100060408

JL DCO SUBMISSION



PROJECT:

SIZEWELL C

DOCUMENT:

APPLICATION DRAWING NOT FOR APPROVAL REGULATION 5(2)(0)

DRAWING TITL

FOXBURROW WOOD FOOTBRIDGE PROPOSED CROSS SECTIONS

DRAWING NO:	REVISION:		
SZC-SZ0204-	01		
DATE:	DRAWN:	SCALE:	
FEB 2020	WN		


SCALE BAR:

AS SHOWN

© Copyright 2020 NNB Generation Company (SZC) Limited. No part of this drawing is to be reproduced without prior permission of NNB Generation Company (SZC) Limited.

SECTION D-D

( CROSS - SECTION AT ABUTMENT )

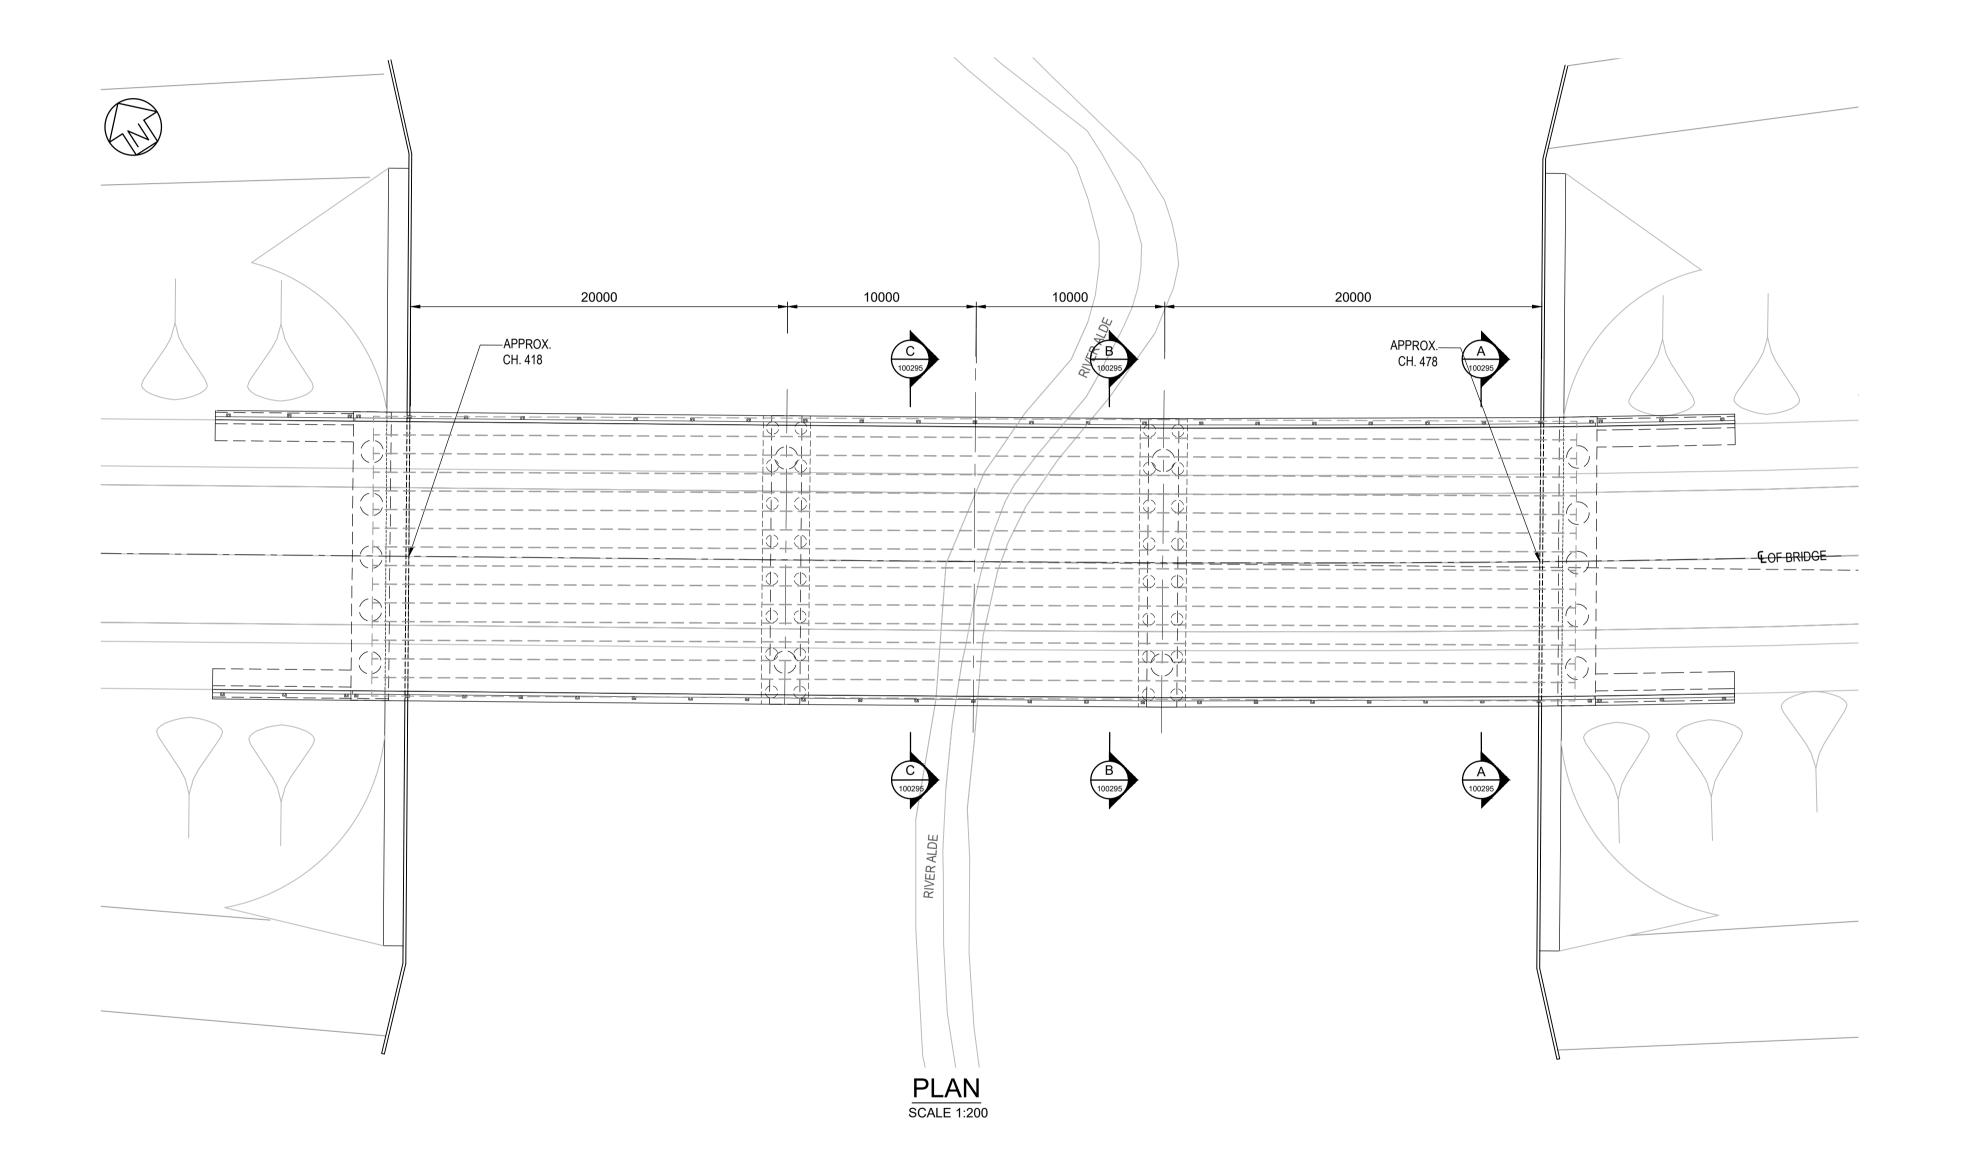

#### NOTES:

- 1. ALL DIMENSIONS ARE IN MILLIMETERS, ALL LEVELS ARE IN METERS ABOVE ORDNANCE DATUM (AOD) AND ALL CHAINAGES ARE IN METERS, UNLESS OTHERWISE INDICATED.
- 2. THIS DRAWING IS FOR PLANNING PURPOSES ONLY AND SHALL NOT BE USED FOR CONSTRUCTION OR ANY OTHER PURPOSE.
- 3. THE DEVELOPMENT SHALL BE PROVIDED AS SHOWN ON DRAWINGS, UNLESS ALTERNATIVE DETAILS ARE SUBMITTED AND APPROVED PURSUANT TO REDUIREMENT.
- 4. FOUNDATION DESIGN IS INDICATIVE ONLY.
- 5. DRAWING TO BE READ IN CONJUNCTION WITH DRAWING 100293, 100295 AND OTHER SCHEME DRAWINGS.

----**,** 

01 FEB 2020 KS JL DCO SUBMISSION SZC CO
VISION DATE DRAWN CHECKED REASONS FOR REVISION / COMMENTS APPROVED

## NOT PROTECTIVELY MARKED

#### COPYRIGHT:

Reproduced from Ordnance Survey map with the permission of Ordnance Survey on behalf of the controller of Her Majesty's Stationery Office © Crown copyright (2019).
All Rights reserved. NNB GenCo Licence: 0100060408



SIZEWELL C

SIZEVVELL

DOCU

APPLICATION DRAWING NOT FOR APPROVAL REGULATION 5(2)(o)

DRAWING TITLE:

RIVER ALDE OVERBRIDGE KEY PLAN FOR CROSS SECTIONS

SZC-SZ0204-XX-000-DRW-100294			01
DATE:	DRAWN:	SCALE:	
FEB 2020	KS	AS SHO	٧N

SCALE BAR:

Scale 1:200

5m 0m 5m 10m

© Copyright 2020 NNB Generation Company (SZC) Limited. No part of this drawing is to be reproduced without prior permission of NNB Generation Company (SZC) Limited.

