



DO NOT SCALE

100
0 10
Millimetres

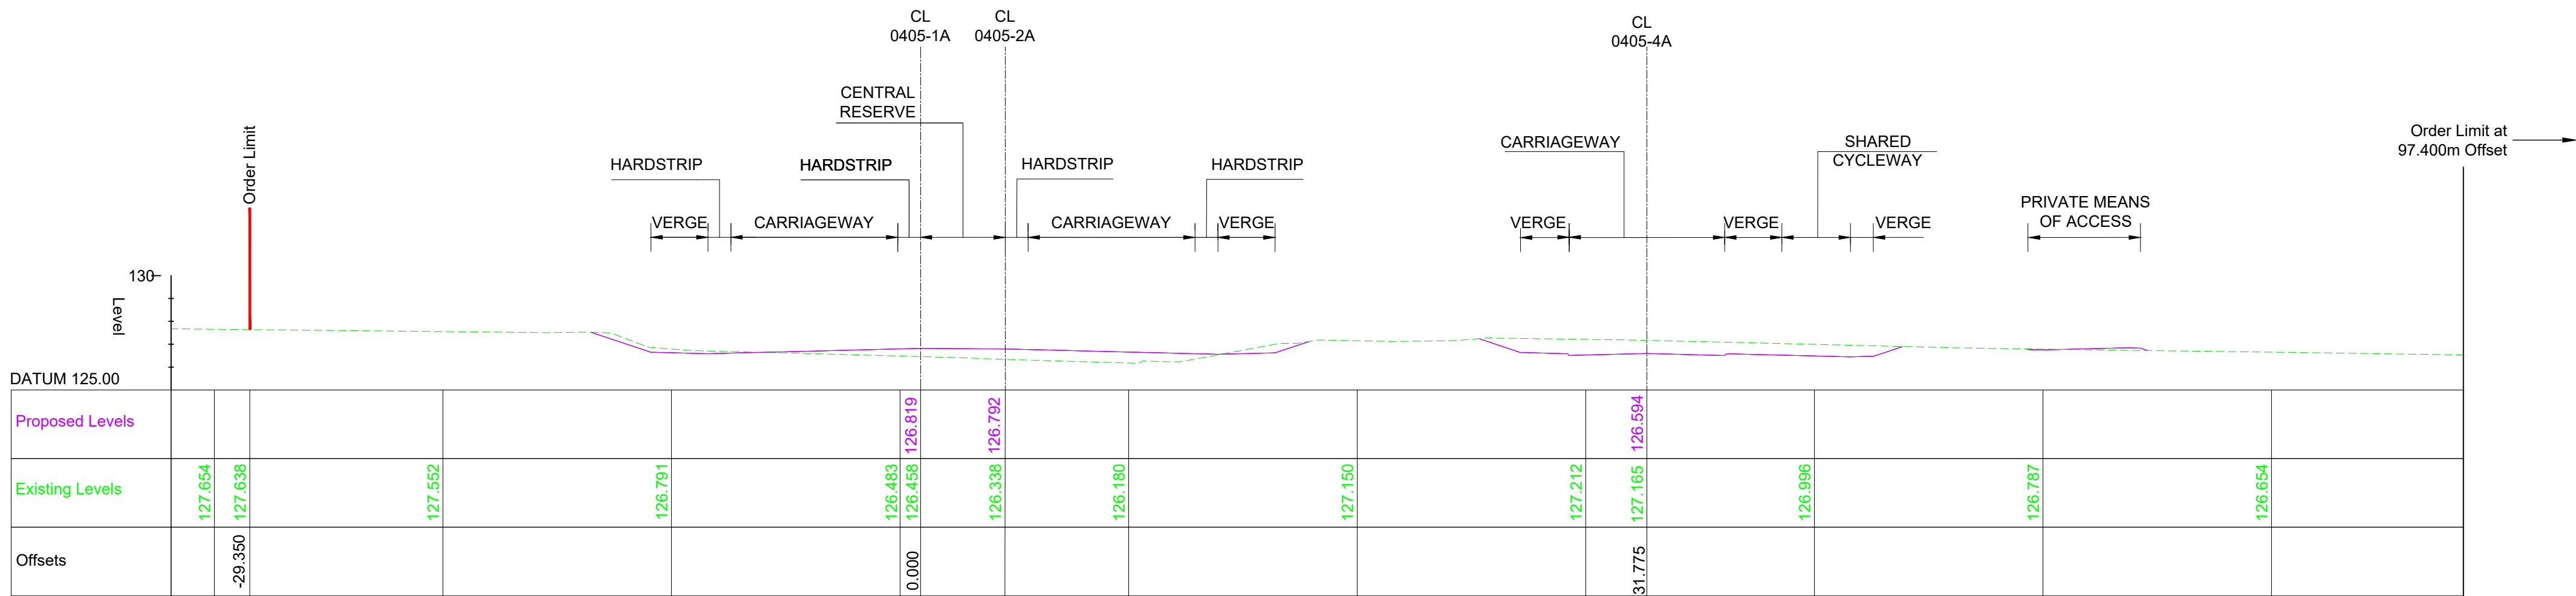

TYPICAL SECTION - CH 30130 WORK No. 0405-1A/2A/4A

SCALE 1:200

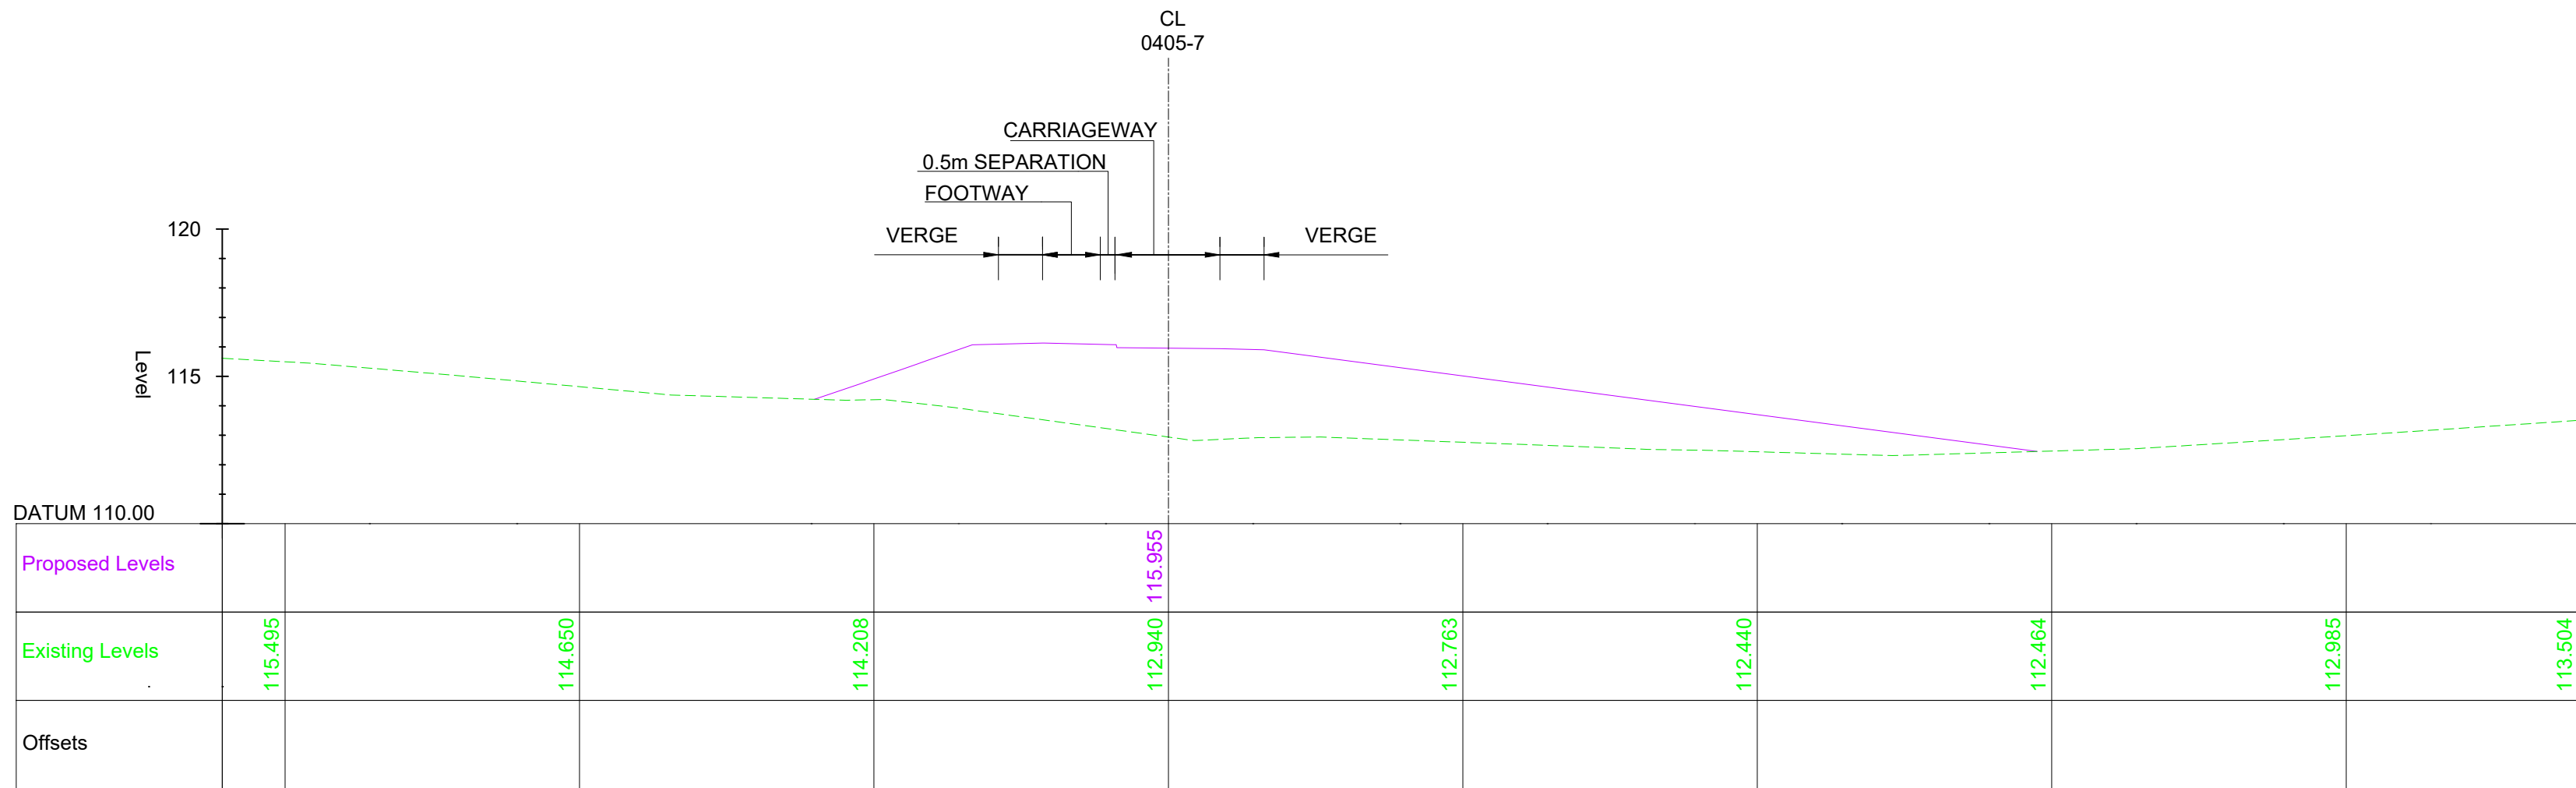

TYPICAL SECTION - CH 590 WORK No.0405 - 7



SCALE 1:200

NOTES

- ALL DIMENSIONS ARE IN METRES UNLESS NOTED OTHERWISE.
- THESE ENGINEERING SECTION DRAWINGS SHOULD BE READ IN CONJUNCTION WITH THE KEY PLAN AND ALONGSIDE OTHER PLANS AND DOCUMENTS IN THE DEVELOPMENT CONSENT ORDER APPLICATION, IN PARTICULAR, THE WORKS PLANS AND SCHEDULE 1 (AUTHORISED DEVELOPMENT) TO THE DEVELOPMENT CONSENT ORDER.
- FOR CHAINAGE PLEASE REFER TO THE ENGINEERING SECTION DRAWINGS (PLAN AND PROFILES).
- WORK No. REFERENCES ARE DETAILED IN THE SCHEDULE 1 (AUTHORISED DEVELOPMENT) TO THE DEVELOPMENT CONSENT ORDER.
- THE DESIGN SHOWN ON THESE ENGINEERING SECTION DRAWINGS IS ILLUSTRATIVE AND WILL BE SUBJECT TO THE DETAILED DESIGN DEVELOPMENT; ANY CHANGES WILL BE LIMITED TO BEING WITHIN THE ORDER LIMITS AND ANY OTHER CONSTRAINTS INCLUDED IN THE DEVELOPMENT CONSENT ORDER.

KEY

- PROPOSED LEVEL
- EXISTING LEVEL
- ORDER LIMIT

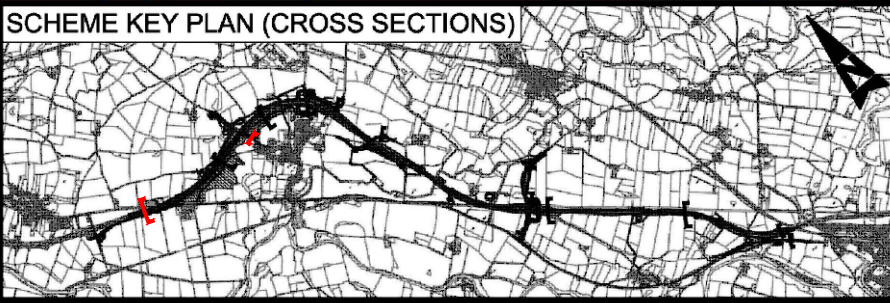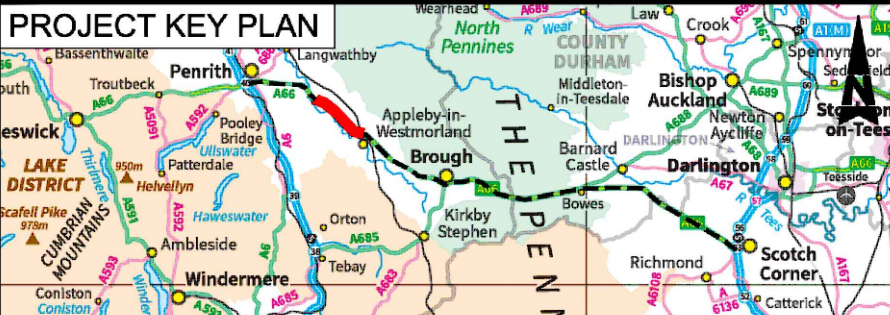

Description						
Status	Revision	Drawn	Checked	Reviewed	Authorised	Issue Date
Description						
Status	Revision	Drawn	Checked	Reviewed	Authorised	Issue Date
Description						
Status	Revision	Drawn	Checked	Reviewed	Authorised	Issue Date
Description						
Status	Revision	Drawn	Checked	Reviewed	Authorised	Issue Date
Description						
Updated to include post DCO changes						
Status	Revision	Drawn	Checked	Reviewed	Authorised	Issue Date
S3	P01	KH1	JG	AS	AS	19/12/24
Drawing Suitability						Status
FOR REVIEW / COMMENT						S3

PINS Reference Number

TR010062/APP/5.18

Client

3 Piccadilly Place
Manchester
M1 3BN

national highways

Project Title

A66 NORTHERN TRANS-PENNINE PROJECT
SCHEME 0405
TEMPLE SOWERBY TO APPELBY

Drawing Title

ENGINEERING SECTION DRAWINGS
(CROSS SECTIONS)
REGULATION 5(2)(O) & 6(2)
SHEET 1 OF 8

Drawing Number	Project	Originator	Volume
HE615324	BBA	HAC	
004_AL_SCHEM	DR	CH	301101
Location	Type	Role	Number
A1	Scale @ A1:	1:200	Project Ref. No. HE615324
Sheet:	1 of 8	Rev:	P01

0 5 10 m