



DO NOT SCALE

100
0 10
Millimetres

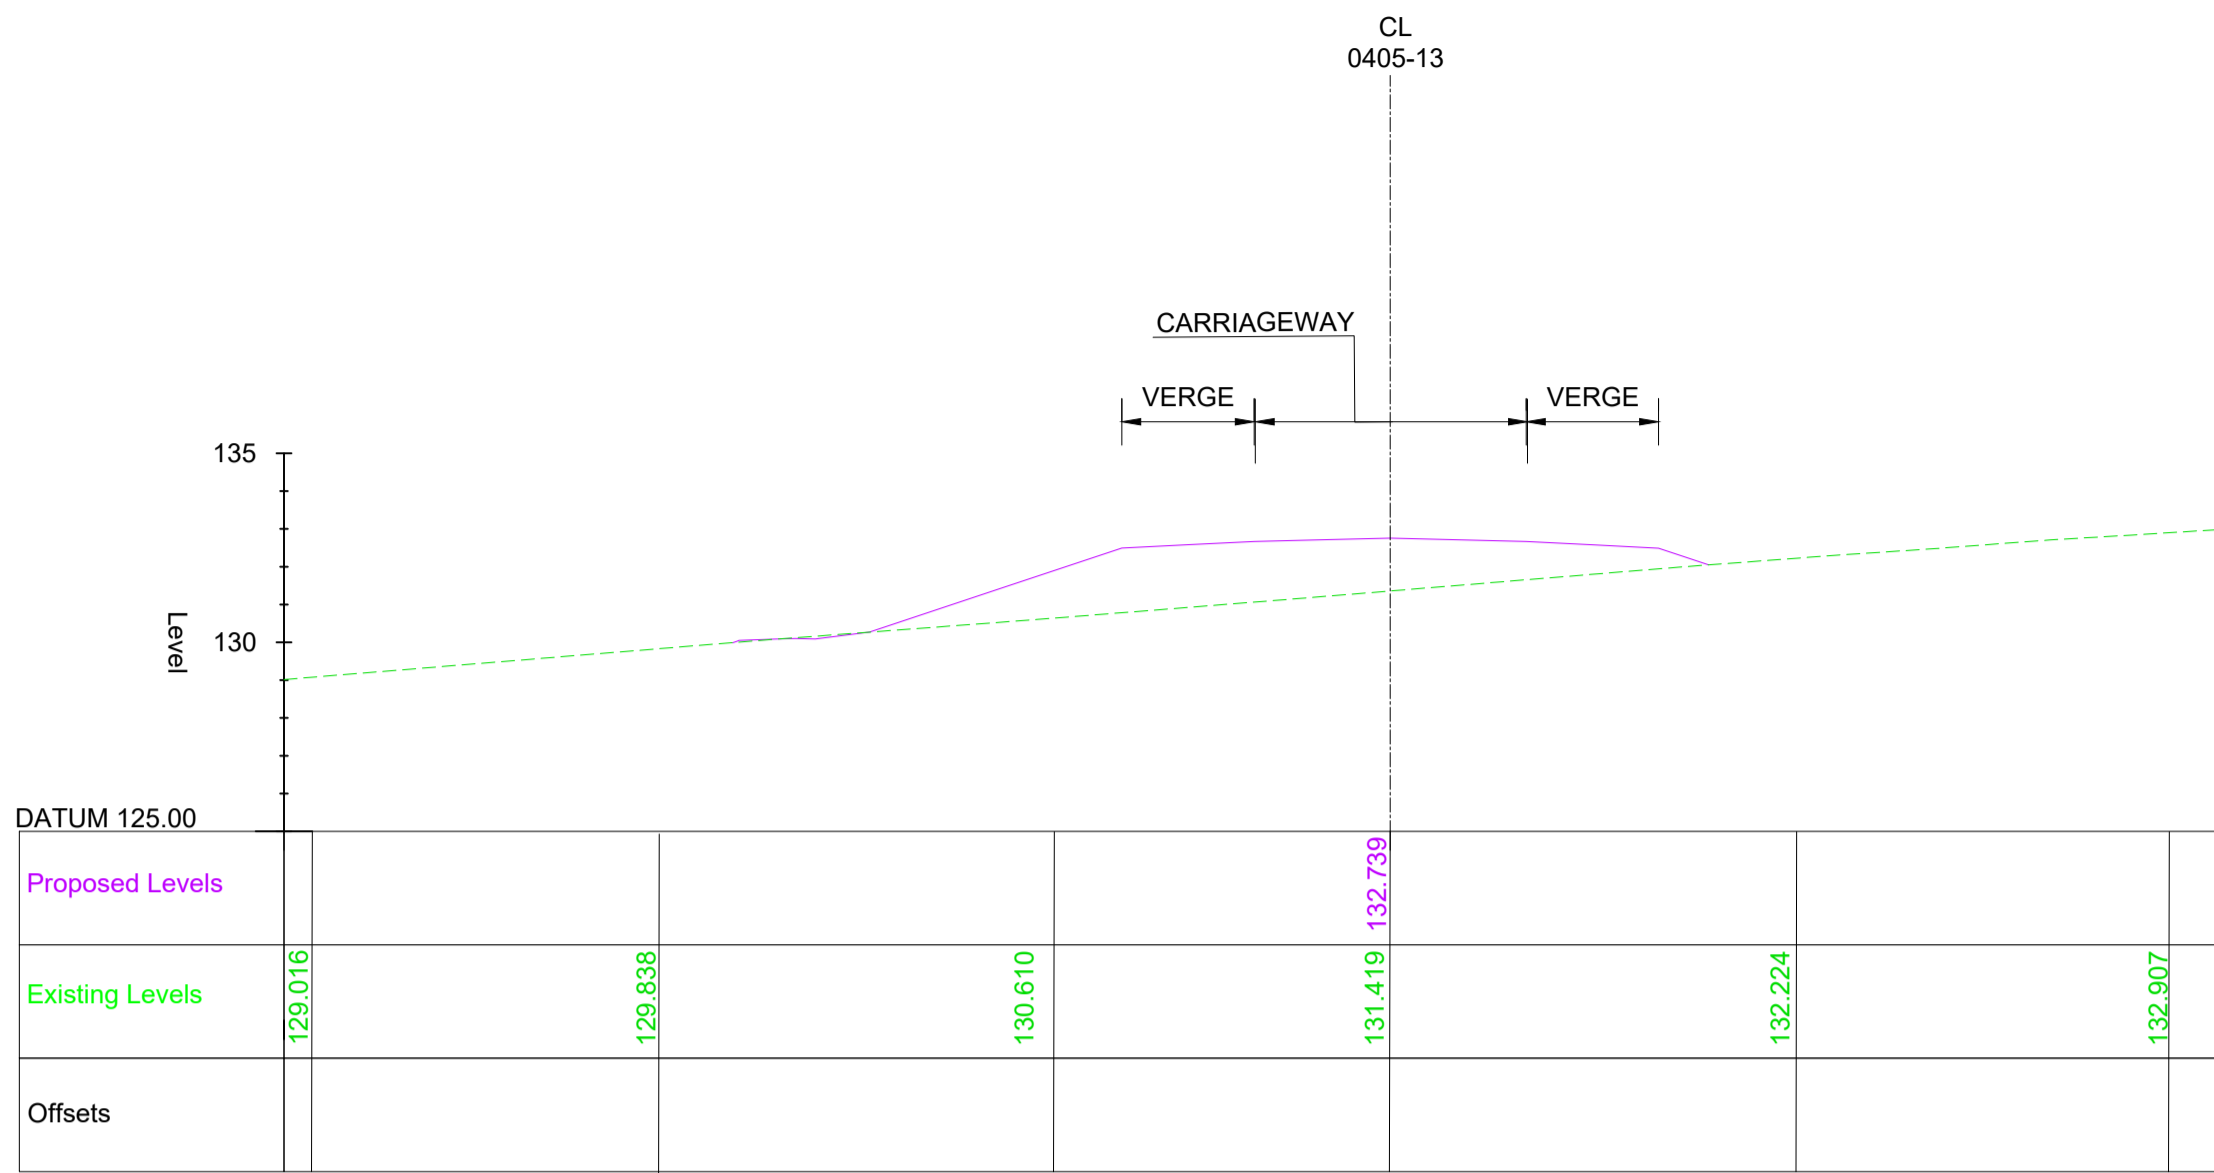

TYPICAL SECTION - CH 520 WORK No. 0405 - 13
SCALE 1:200

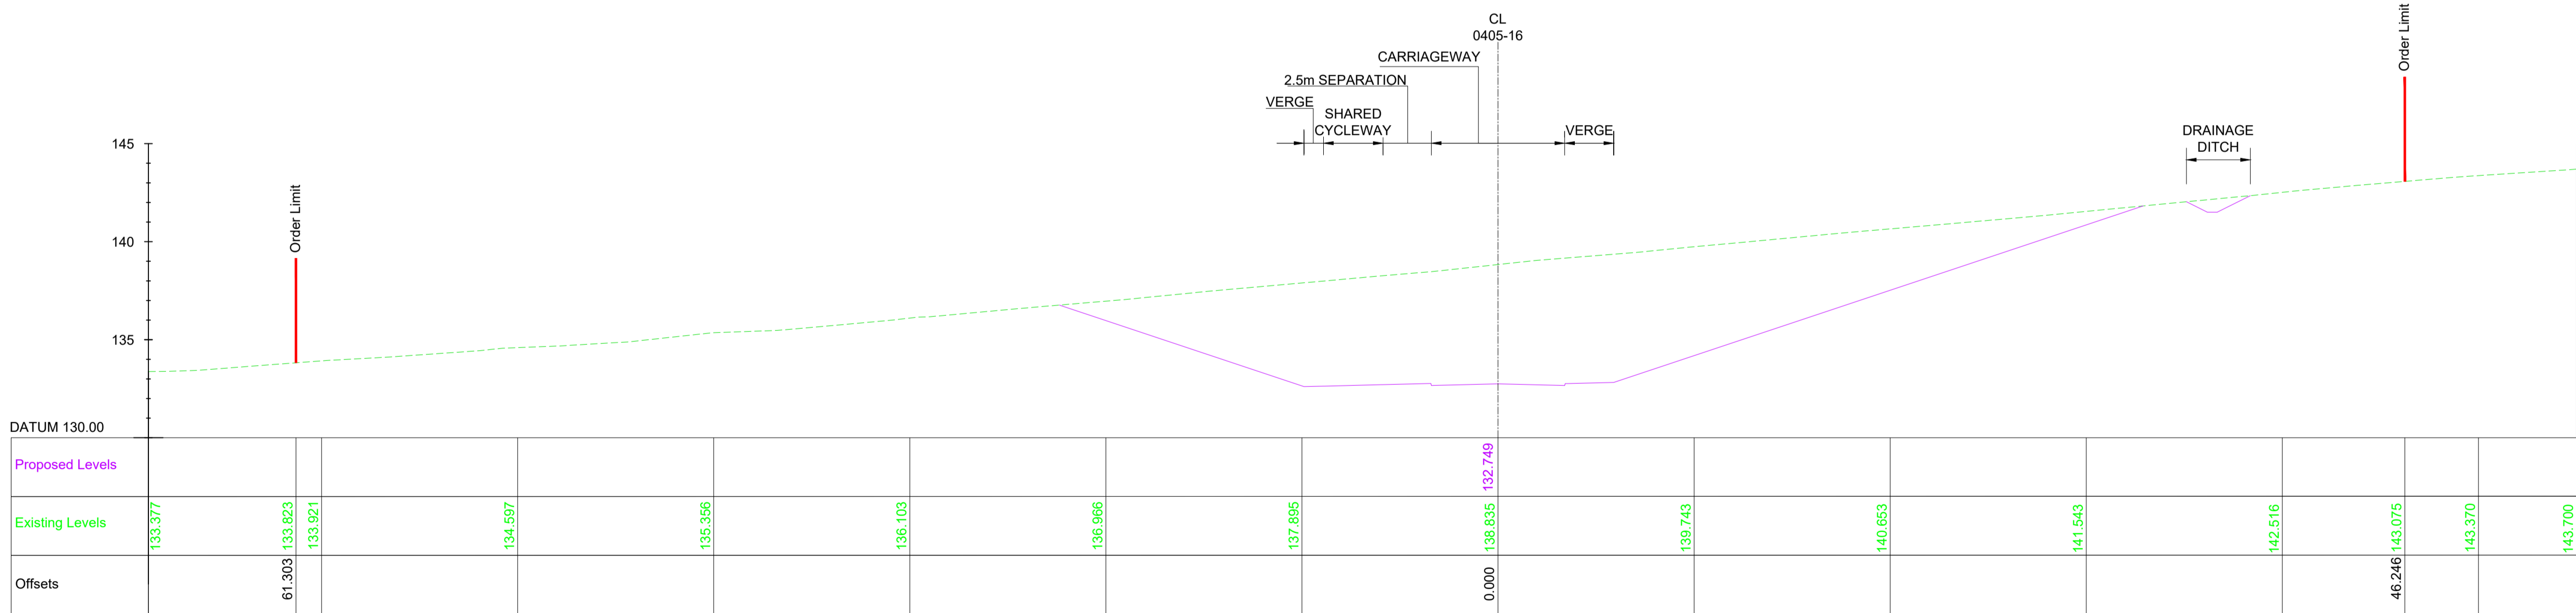



TYPICAL SECTION - CH 580 WORK No. 0405 - 16
SCALE 1:200

NOTES

- ALL DIMENSIONS ARE IN METRES UNLESS NOTED OTHERWISE.
- THESE ENGINEERING SECTION DRAWINGS SHOULD BE READ IN CONJUNCTION WITH THE KEY PLAN AND ALONGSIDE OTHER PLANS AND DOCUMENTS IN THE DEVELOPMENT CONSENT ORDER APPLICATION. IN PARTICULAR, THE WORKS PLANS AND SCHEDULE 1 (AUTHORISED DEVELOPMENT) TO THE DEVELOPMENT CONSENT ORDER.
- FOR CHAINAGE PLEASE REFER TO THE ENGINEERING SECTION DRAWINGS (PLAN AND PROFILES).
- WORK No. REFERENCES ARE DETAILED IN THE SCHEDULE 1 (AUTHORISED DEVELOPMENT) TO THE DEVELOPMENT CONSENT ORDER.
- THE DESIGN SHOWN ON THESE ENGINEERING SECTION DRAWINGS IS ILLUSTRATIVE AND WILL BE SUBJECT TO THE DETAILED DESIGN DEVELOPMENT; ANY CHANGES WILL BE LIMITED TO BEING WITHIN THE ORDER LIMITS AND ANY OTHER CONSTRAINTS INCLUDED IN THE DEVELOPMENT CONSENT ORDER.

KEY

- PROPOSED LEVEL
- EXISTING LEVEL
- ORDER LIMIT

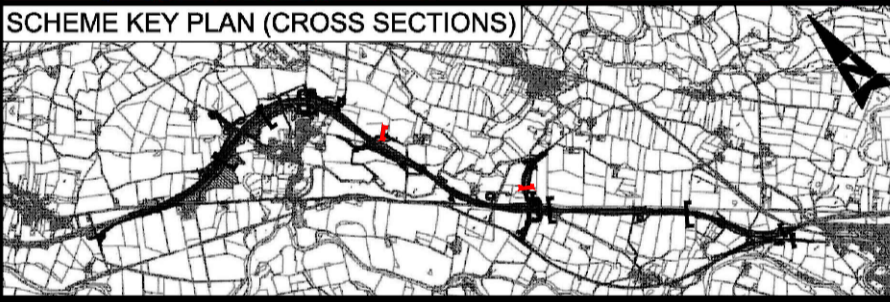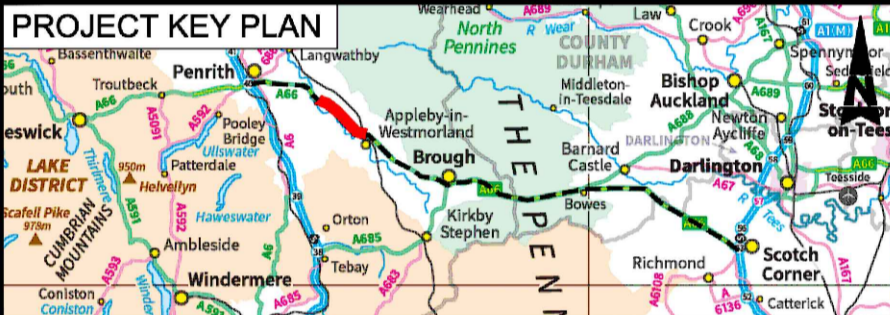

Description						
Status	Revision	Drawn	Checked	Reviewed	Authorised	Issue Date
Description						
Status	Revision	Drawn	Checked	Reviewed	Authorised	Issue Date
Description						
Status	Revision	Drawn	Checked	Reviewed	Authorised	Issue Date
Description						
Status	Revision	Drawn	Checked	Reviewed	Authorised	Issue Date
S4	P01	KH1	JG	AS	AS	19/12/24
Description						
Status	Revision	Drawn	Checked	Reviewed	Authorised	Issue Date
S3	P02	KH1	JG	AS	AS	31/07/25
Drawing Suitability						Status
FOR REVIEW / COMMENT						S3

PINS Reference Number
TR010062/APP/5.18

Client
3 Piccadilly Place
Manchester
M1 3BN

Project Title
A66 NORTHERN TRANS-PENNINE PROJECT
SCHEME 0405
TEMPLE SOWERBY TO APPELBY

Drawing Title
ENGINEERING SECTION DRAWINGS
(CROSS SECTIONS)
REGULATION 5(2)(O) & 6(2)
SHEET 5 OF 8

Drawing Number
Project HE615324 - BBA - HAC
004_AL_SCHEM - DR - CH - 301105
Location
Type Role Number
Original Size: A1 Scale: 1:200 Project Ref. No: HE615324 Sheet: 5 of 8 Rev: P02

0 5 10 m